

Point #	Northing	Easting
P001	1705899.267	1474266.066
P002	1705886.984	1474263.484
P005	1705839.340	1474285.629
P006	1705813.889	1474280.274
P007	1705805.309	1474285.756
P008	1705739.651	1474264.493
P009	1705713.180	1474258.896
P010	1705704.543	1474264.467
P011	1705726.487	1474229.766
P012	1705719.102	1474235.324
P013	1705695.890	1474230.489
P014	1705691.781	1474222.462
P015	1705743.733	1474272.722
P016	1705691.463	1474210.486
P017	1705686.410	1474175.688
P018	1705684.990	1474182.007
P019	1705682.271	1474190.001
P020	1705678.655	1474197.634
P021	1705672.926	1474204.497
P022	1705660.874	1474213.411
P023	1705647.707	1474218.338
P024	1705643.477	1474218.893
P025	1705632.333	1474216.861
P026	1705620.674	1474214.418
P027	1705616.408	1474213.532
P028	1705610.941	1474205.295
P029	1705647.323	1474252.759
P030	1705641.877	1474243.776
P031	1705627.153	1474240.646
P032	1705615.511	1474238.171
P033	1705603.038	1474235.520
P034	1705596.759	1474236.734
P035	1705593.413	1474241.353
P036	1705592.320	1474245.769
P037	1705591.462	1474253.702
P038	1705454.687	1474171.993
P039	1705389.046	1474158.023
P040	1705469.006	1474214.697
P041	1705467.063	1474214.496
P042	1705460.058	1474217.892
P043	1705458.149	1474222.482
P044	1705457.002	1474232.348
P045	1705444.379	1474231.192
P046	1705445.486	1474220.978
P047	1705445.300	1474215.576
P048	1705441.775	1474210.231
P049	1705435.048	1474207.434
P050	1705182.272	1474153.714
P051	1705113.584	1474139.184
P052	1705117.832	1474100.979
P053	1705064.010	1474089.721
P054	1705044.708	1474085.726
P055	1705034.411	1474083.632
P056	1705087.601	1474133.667
P057	1705081.752	1474125.093
P058	1705055.216	1474119.514
P059	1705046.191	1474124.914
P060	1705012.259	1474079.075
P061	1704999.160	1474076.349
P062	1704987.175	1474112.669
P063	1704982.148	1474104.755
P064 P065	1704976.236 1704953.656	1474103.543
	1704953.656	1474098.963
P066 P067		1474083.389 1474089.761
	1704869.624 1704758.736	
P068 P069	1704758.736	1474012.768 1474021.941
P069 P070	1704756.514	1474021.941
1 0/0	1707/44.010	17/7023.103

Point #	Northing	Easting
P071	1704727.889	1474027.811
P072	1704716.285	1474025.388
P073	1704661.151	1474013.952
P074	1704653.847	1474010.612
P075	1704648.593	1474004.198
P076	1704646.798	1473999.283
P077	1704648.114	1473991.631
P078	1704650.561	1473980.286
P079	1704760.479	1474067.016
P080	1704734.048	1474061.477
P081	1704730.198	1474053.861
P082	1704725.821	1474052.973
P083	1704711.260	1474050.021
P084	1704708.602	1474049.482
P085	1704702.505	1474055.049
P086	1704668.004	1474047.806
P087	1704663.463	1474039.105
P088	1704627.314	1474057.753
P089	1704628.017	1474050.877
P090	1704628.007	1474044.643
P091	1704626.158	1474038.920
P092	1704624.405	1474036.067
P093	1704612.415	1474028.456
P094	1704600.578	1474026.098
P095	1704589.823	1474031.652
P096	1704483.641	1474009.726
P097	1704630.273	1473959.717
P098	1704624.512	1473986.671
P099	1704622.654	1473993.598
P100	1704619.247	1473998.500
P101	1704616.805	1474000.437
P102	1704605.171	1474002.568
P103	1704595.766	1474000.582
P104	1704589.717	1473991.595
P105	1704399.005	1473992.261
P106	1704374.691	1473987.253
P107	1704368.224	1473988.412
P108	1704365.360	1474000.486
P109	1704362.771	1474024.441
P110	1704336.674	1474022.862
P111	1704340.596	1473985.041
P112	1704337.443	1473977.301
P113	1704332.379	1473972.134
P114	1704325.575	1473969.349
P115	1704317.188	1473967.664
P116	1704308.866	1473973.611
P117	1704364.026	1473944.809
P118	1704354.788	1473950.375
P119	1704329.444	1473945.247
P120	1704324.363	1473936.698
P121	1704270.411	1473925.489
P122	1704243.072	1473919.803
P123	1704233.747	1473925.519
P124	1704214.901	1473923.319
P125	1704214.901	1473912.790
P126	1704141.229	1473898.674
P127	1704134.271	1473895.100
P128	1704136.130	1473888.033
P129	1704140.185	1473881.406
P130	1704234.189	1473958.224
P131	1704228.621	1473949.454
P132	1704228.821	1473949.434
P133	1704209.778	1473951.128
P133	1704139.344	1473931.126
P134 P135	1704135.199	1473937.745
P135 P136	1704130.241	1473937.844
P137	1704127.527	1473957.166
P138	1704101.300	1473947.841
P139	1704101.415	1473946.267

# DO NOT SCALE

1. THIS DRAWING SHOULD BE READ IN CONJUNCTION WITH ALL RELATED DOCUMENTATION, DRAWINGS AND STANDARD DETAILS.

2. ALL DIMENSIONS ARE IN METRES UNLESS NOTED OTHERWISE.

FOILL #	Nor trillig	Eusting
P141	1704100.360	1473927.657
P142	1704099.355	1473925.964
P143	1704090.712	1473919.525
P144	1704069.213	1473912.863
P145	1704044.873	1473905.064
P146	1704035.143	1473909.585
P147	1704113.208	1473874.260
P148	1704110.472	1473878.993
P149	1704105.244	1473886.467
P150	1704099.651	1473891.466
P151	1704095.068	1473893.372
P152	1704084.501	1473892.935
P153	1704079.290	1473882.985
P154	1704077.168	1473882.307
P155	1703999.991	1473897.677
P156	1703995.574	1473888.312
P157	1703968.898	1473879.290
P158	1703959.476	1473883.628
P159	1703940.739	1473877.157
P160	1703946.733	1473865.280
P161	1703899.802	1473864.120
P162	1703899.002	1473866.063
P163	1703896.647	1473872.067
P164	1703896.647	1473972.007
	1703952.214	
P165 P166	1703932.214	1473839.436 1473834.542
P167	1703943.622	1473826.847
P168	1703945.784	1473806.885
P169	1703931.812	1473783.038
P170	1703926.819	1473795.431
P171	1703919.473	1473806.978
P172	1703915.500	1473811.130
P173	1703904.180	1473817.819
P174	1703894.453	1473820.830
P175	1703879.575	1473821.579
P176	1703871.575	1473819.342
P177	1703866.931	1473817.763
P178	1703855.560	1473813.899
P179	1703850.198	1473804.753
P180	1703854.007	1473894.808
P181	1703863.586	1473863.361
P182	1703866.160	1473854.047
P183	1703864.329	1473849.596
P184	1703860.431	1473843.282
P185	1703858.683	1473841.534
P186	1703847.850	1473836.751
P187	1703837.399	1473841.402
P188	1703824.100	1473836.807
P189	1703714.070	1473798.764
P190	1703709.338	1473790.181
P191	1703697.701	1473786.201
P192	1703689.552	1473790.310
P193	1703726.242	1473761.331
P194	1703717.844	1473765.293
P195	1703706.033	1473761.182
P196	1703701.984	1473752.843
P199	1704622.796	1474211.988
P200	1705861.788	1474290.284
P201	1705924.734	1474310.919
P202	1705919.485	1474302.775
P203	1705861.374	1474290.556

Point #

Easting

	115])
	Amber Court, William Armstrong Drive, Newcastle upon Tyne, NE4 7YQ, UK T+ 44 (0) 191 226 2000, F+ 44 (0) 191 226 2104 wsp.com
ENT:	

UNTIL TECHNICAL APPROVAL HAS BEEN OBTAINED FROM THE RELEVANT LOCAL AUTHORITIES OR STATUTORY BODIES, IT SHOULD BE UNDERSTOOD THAT ALL DRAWINGS ARE ISSUED AS

CONTRACTOR AND / OR EMPLOYER COMMENCE WORK PRIOR TO APPROVAL BEING GIVEN, IT IS ENTIRELY AT THEIR OWN RISK

S2 - FOR INFORMATION

PO2 10/10/24 AB UPDATED FOLLOWING CLIENT REQUIREMENTS

P01 12/09/24 NR ISSUED FOR CLIENT APPROVAL

REV DATE BY DESCRIPTION

LINTHORPE ROAD RESTORATION


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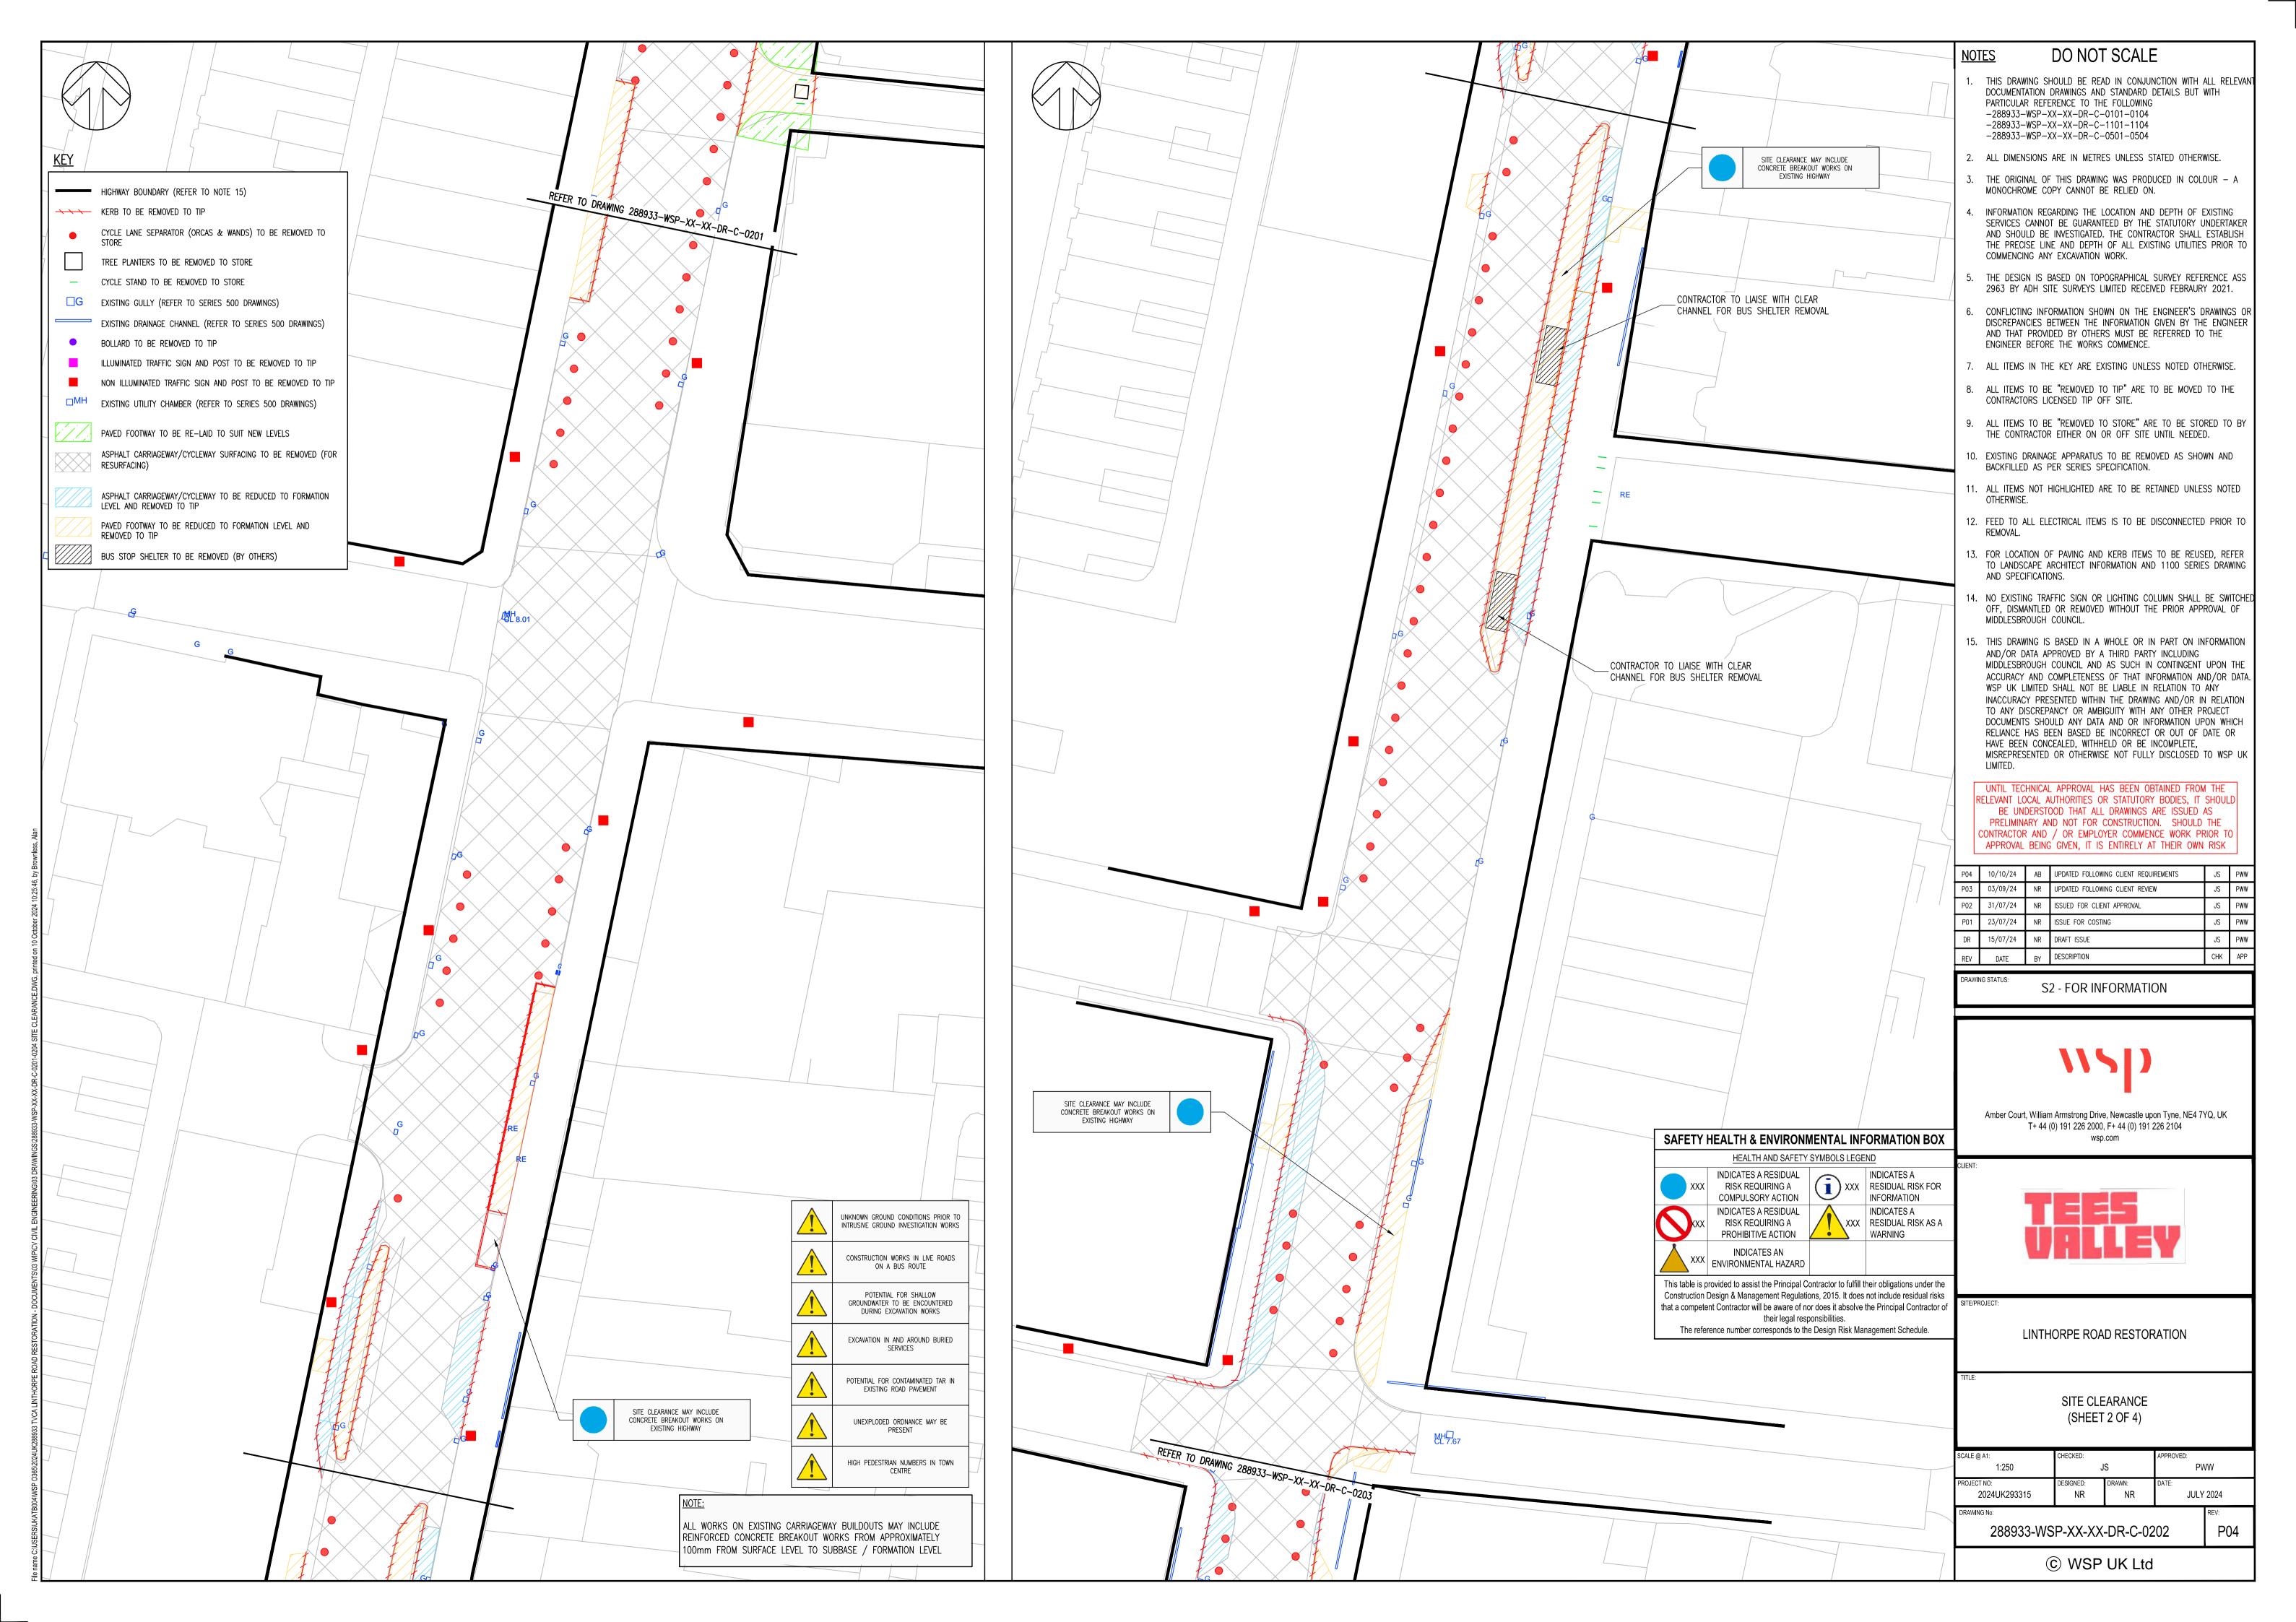
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PROJECT NO: 2024UK293315	DESIGNED:	DRAWN: NR	DATE: JULY 2024
DRAWING No:			REV:


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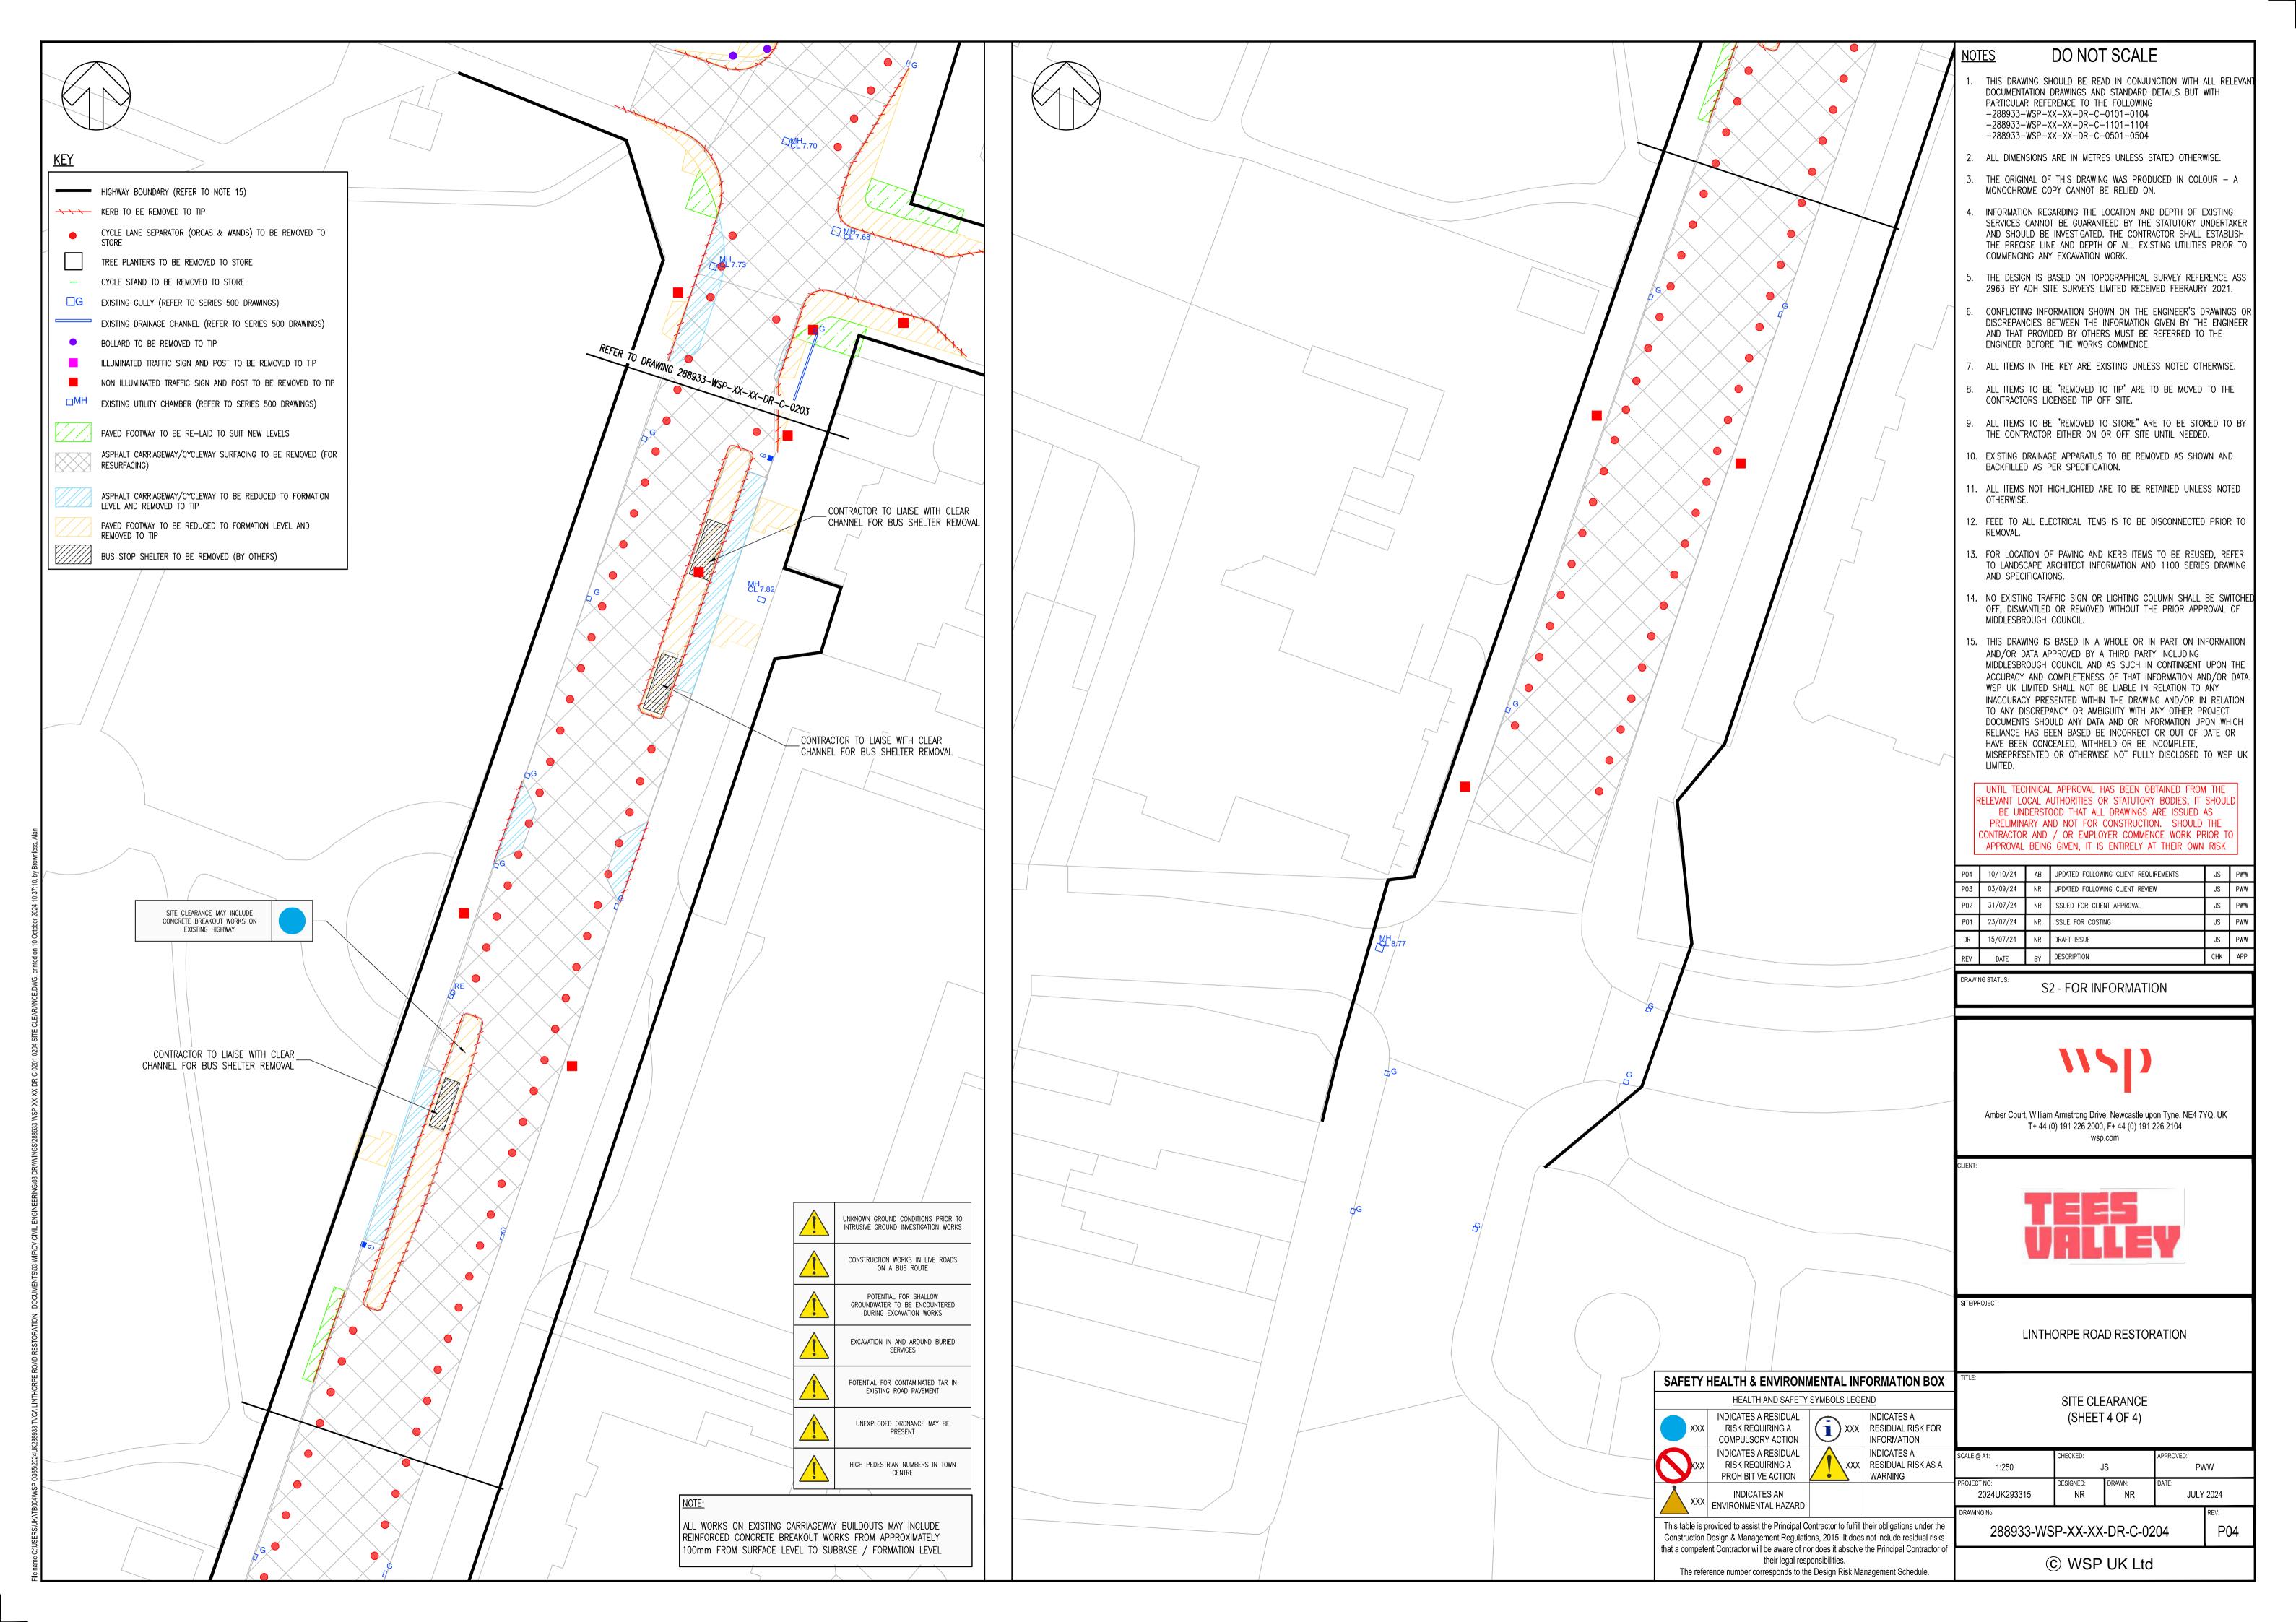
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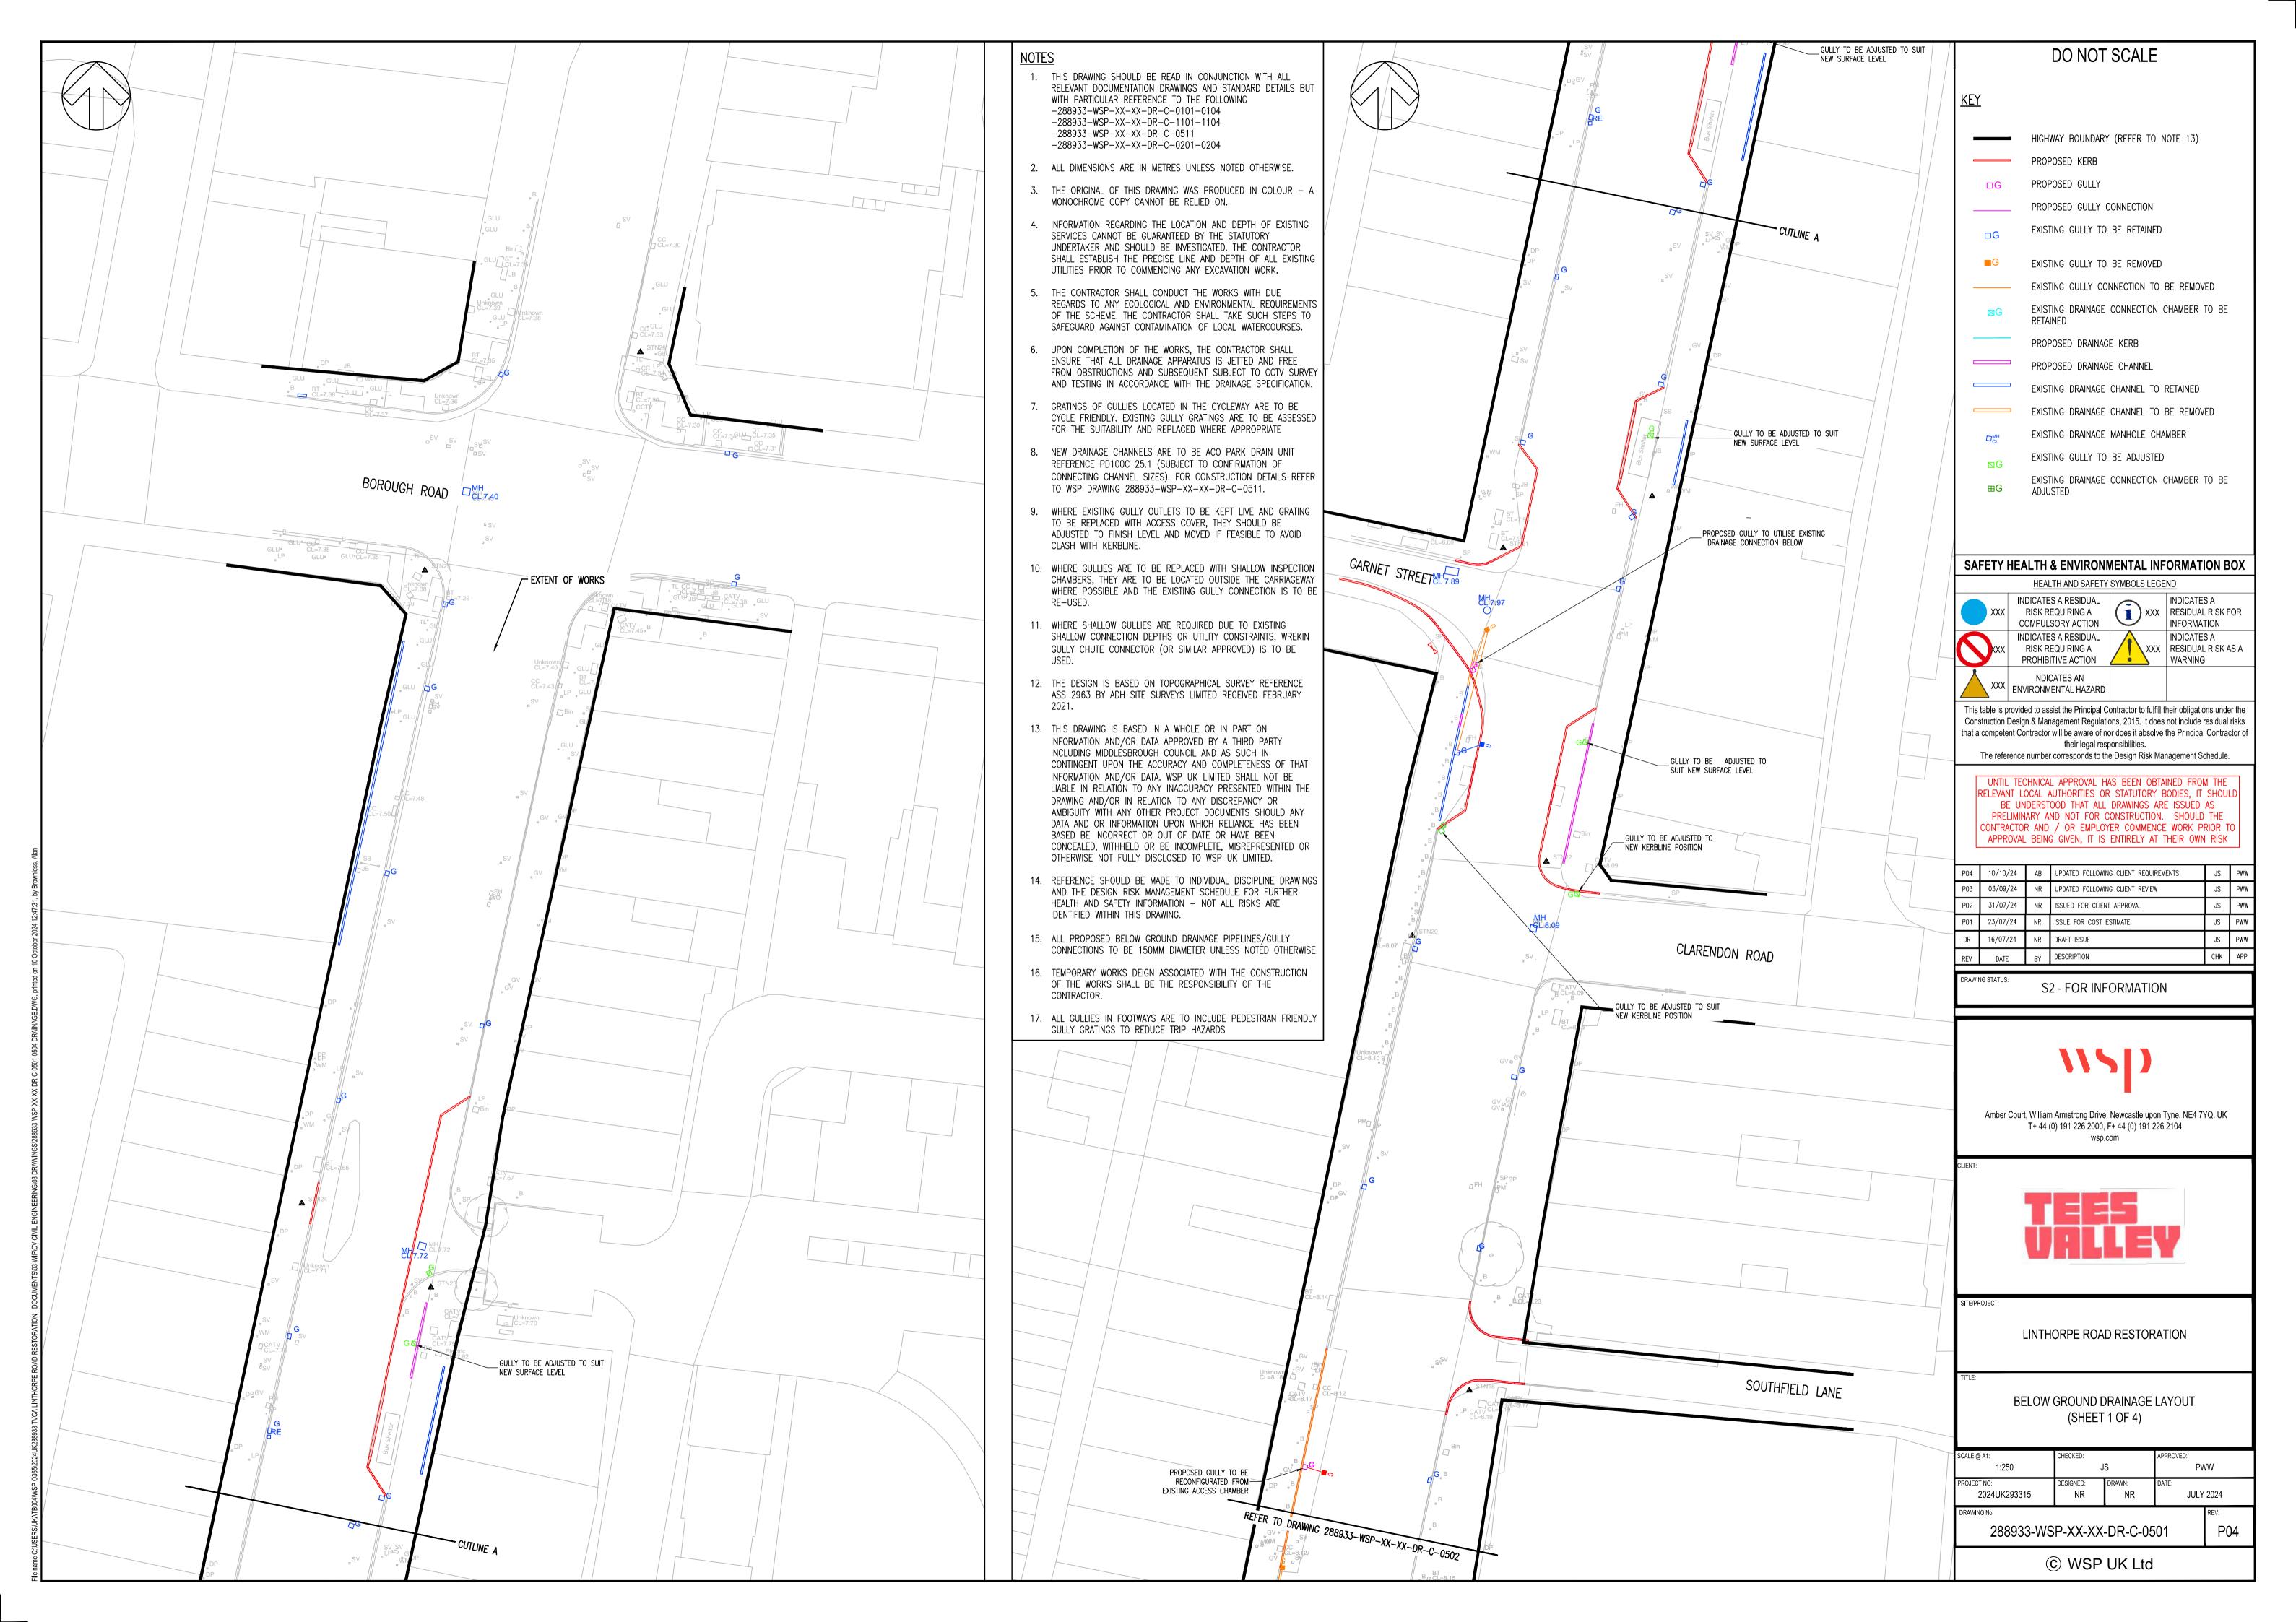
P02










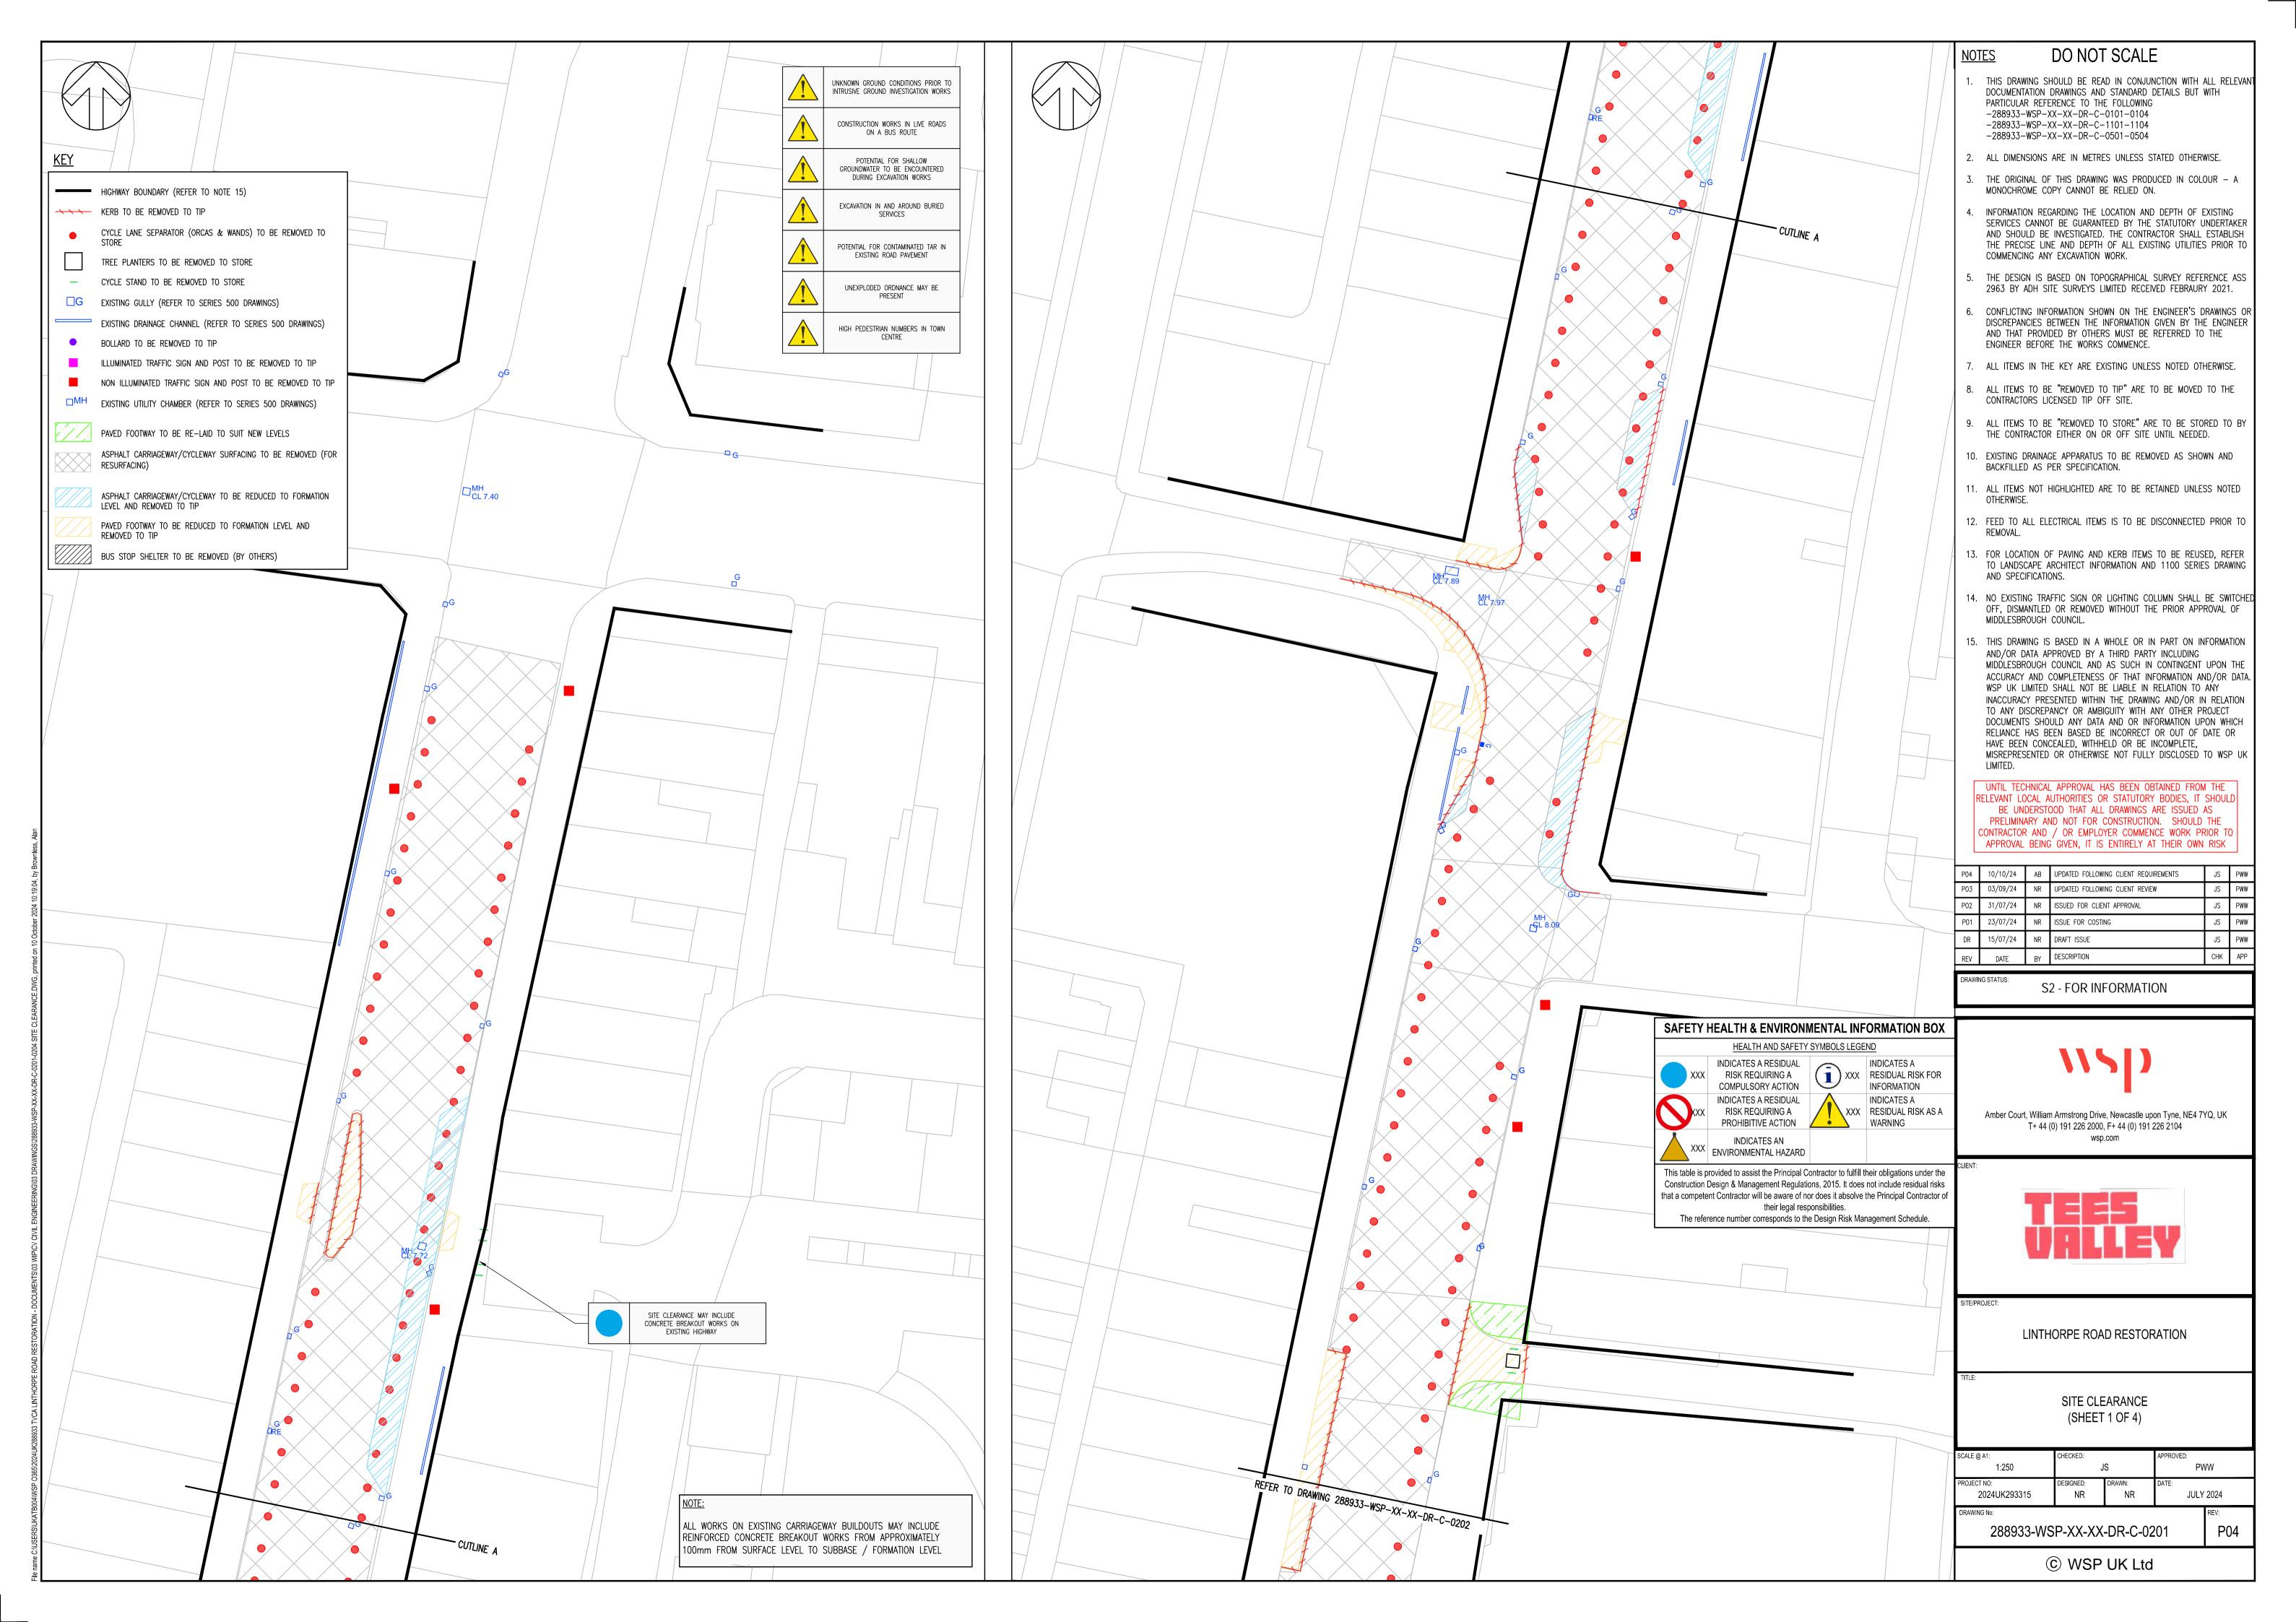


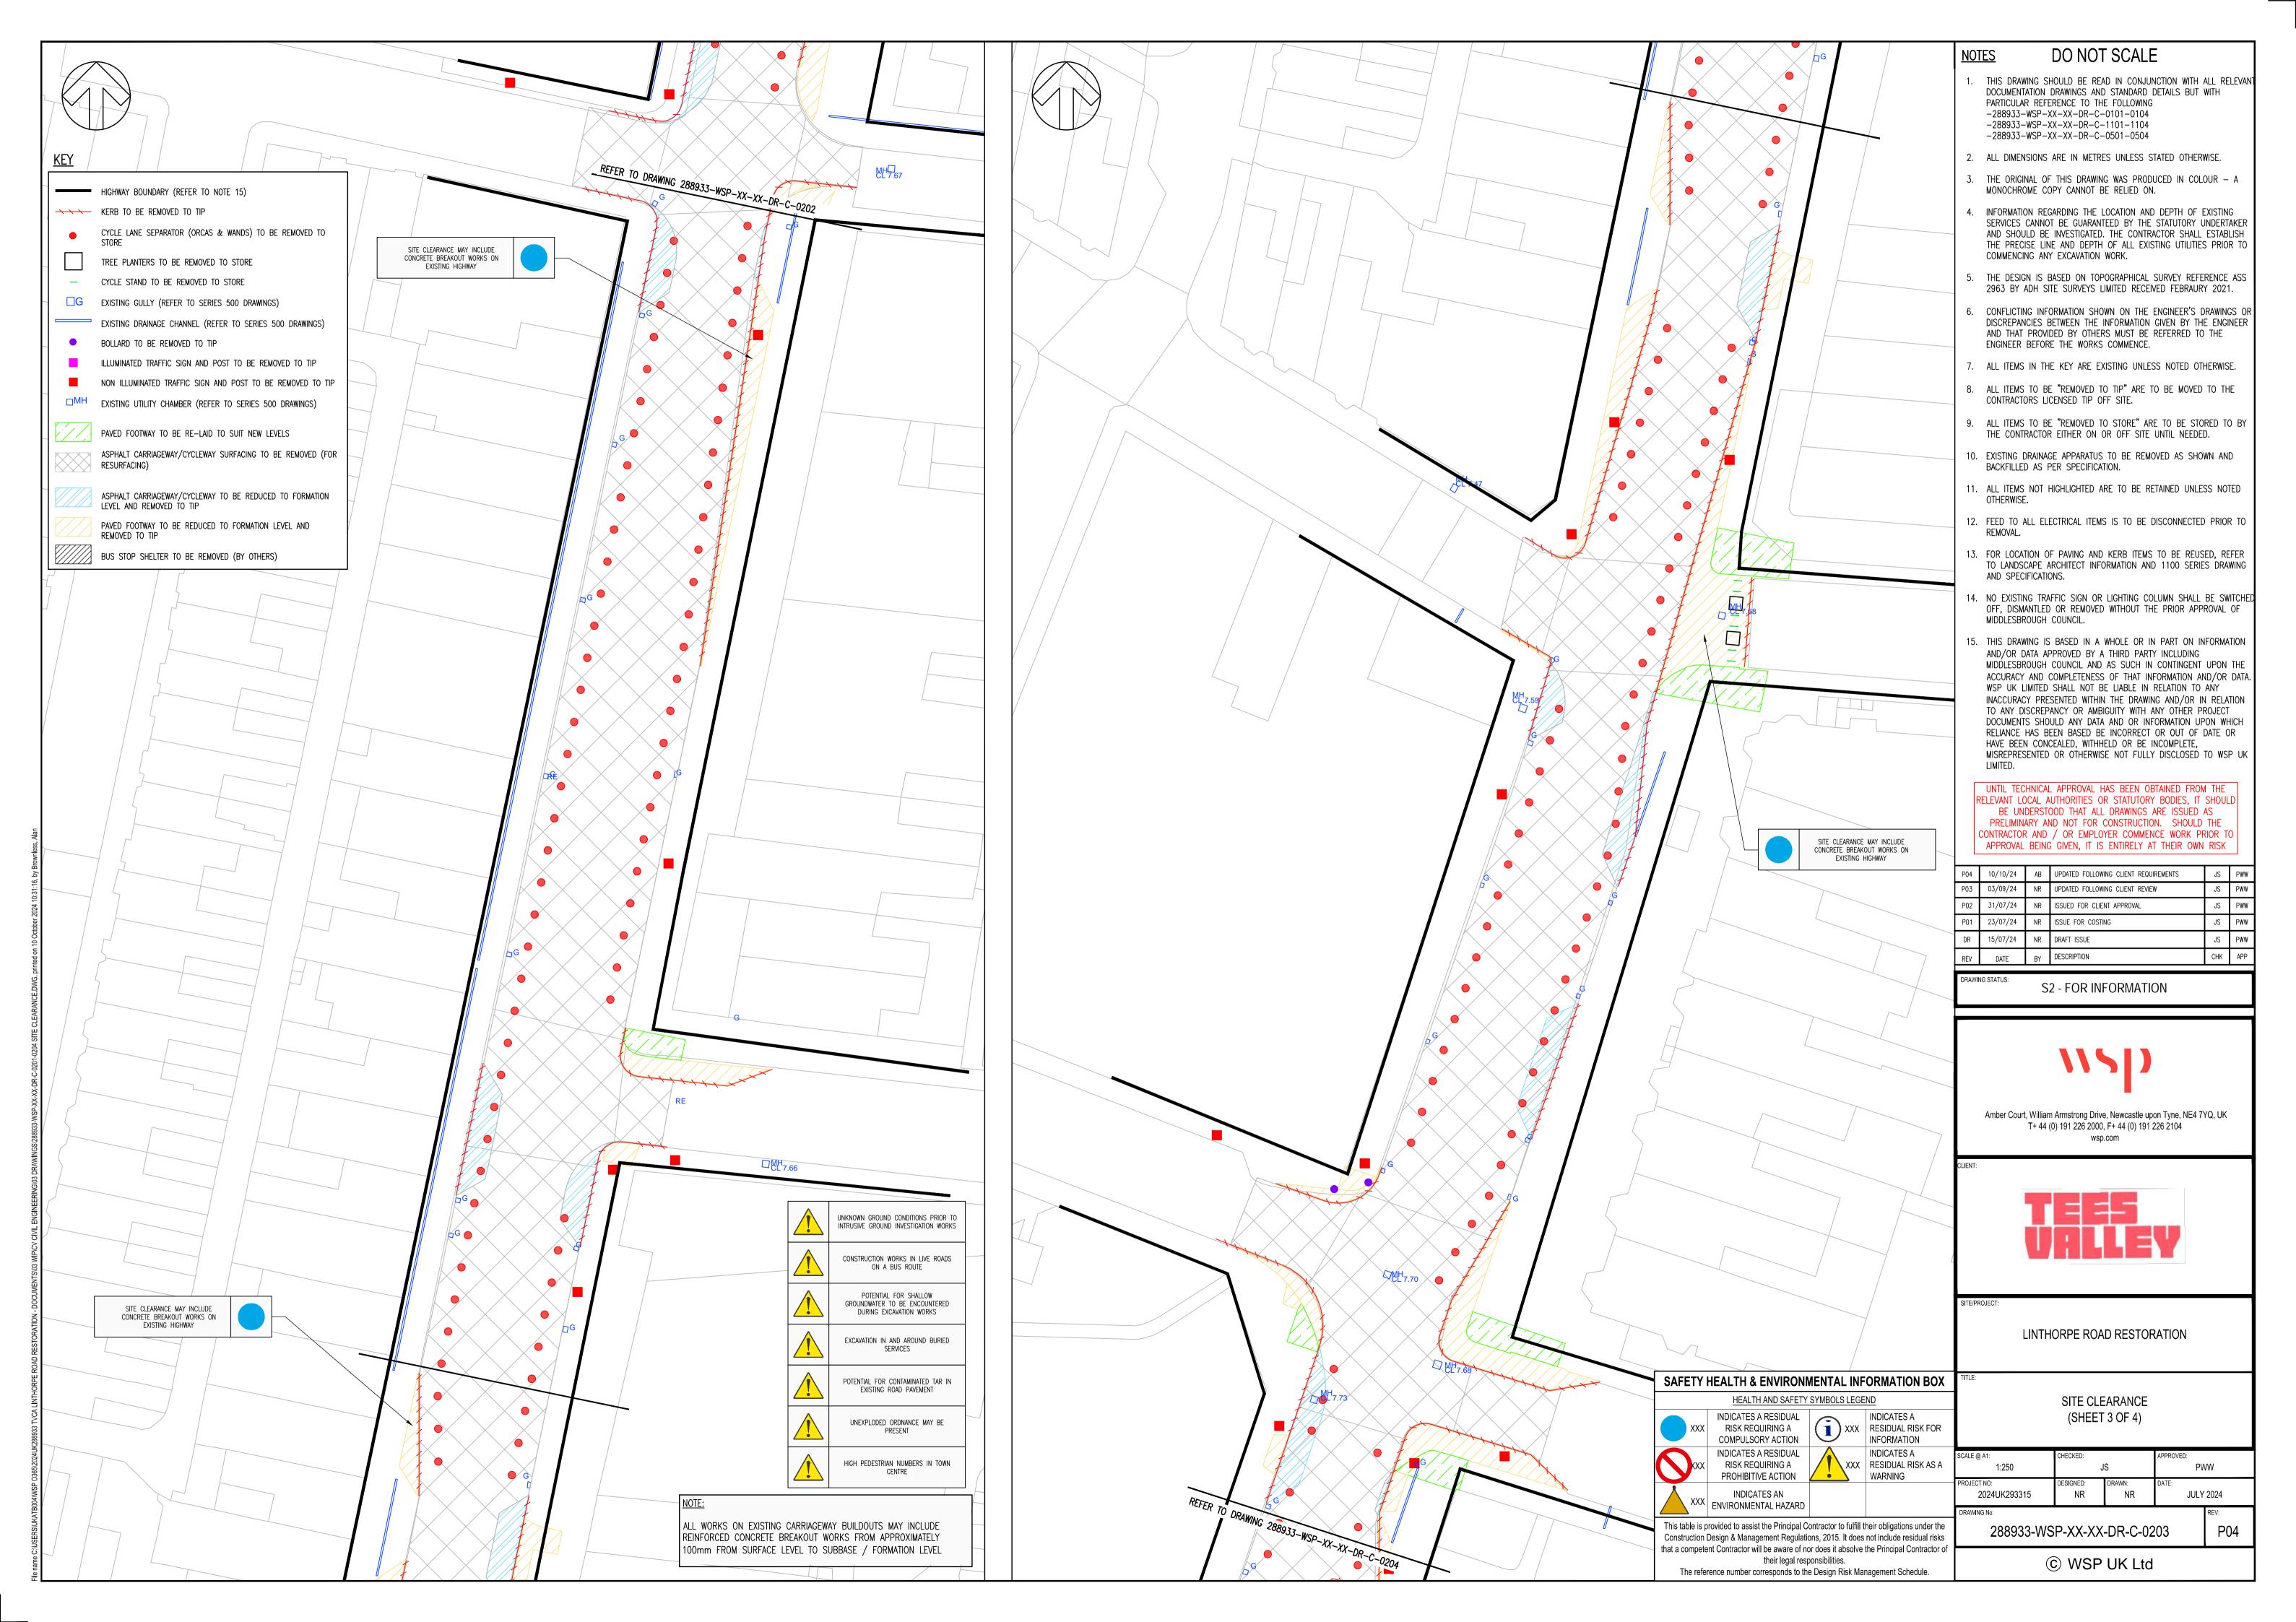

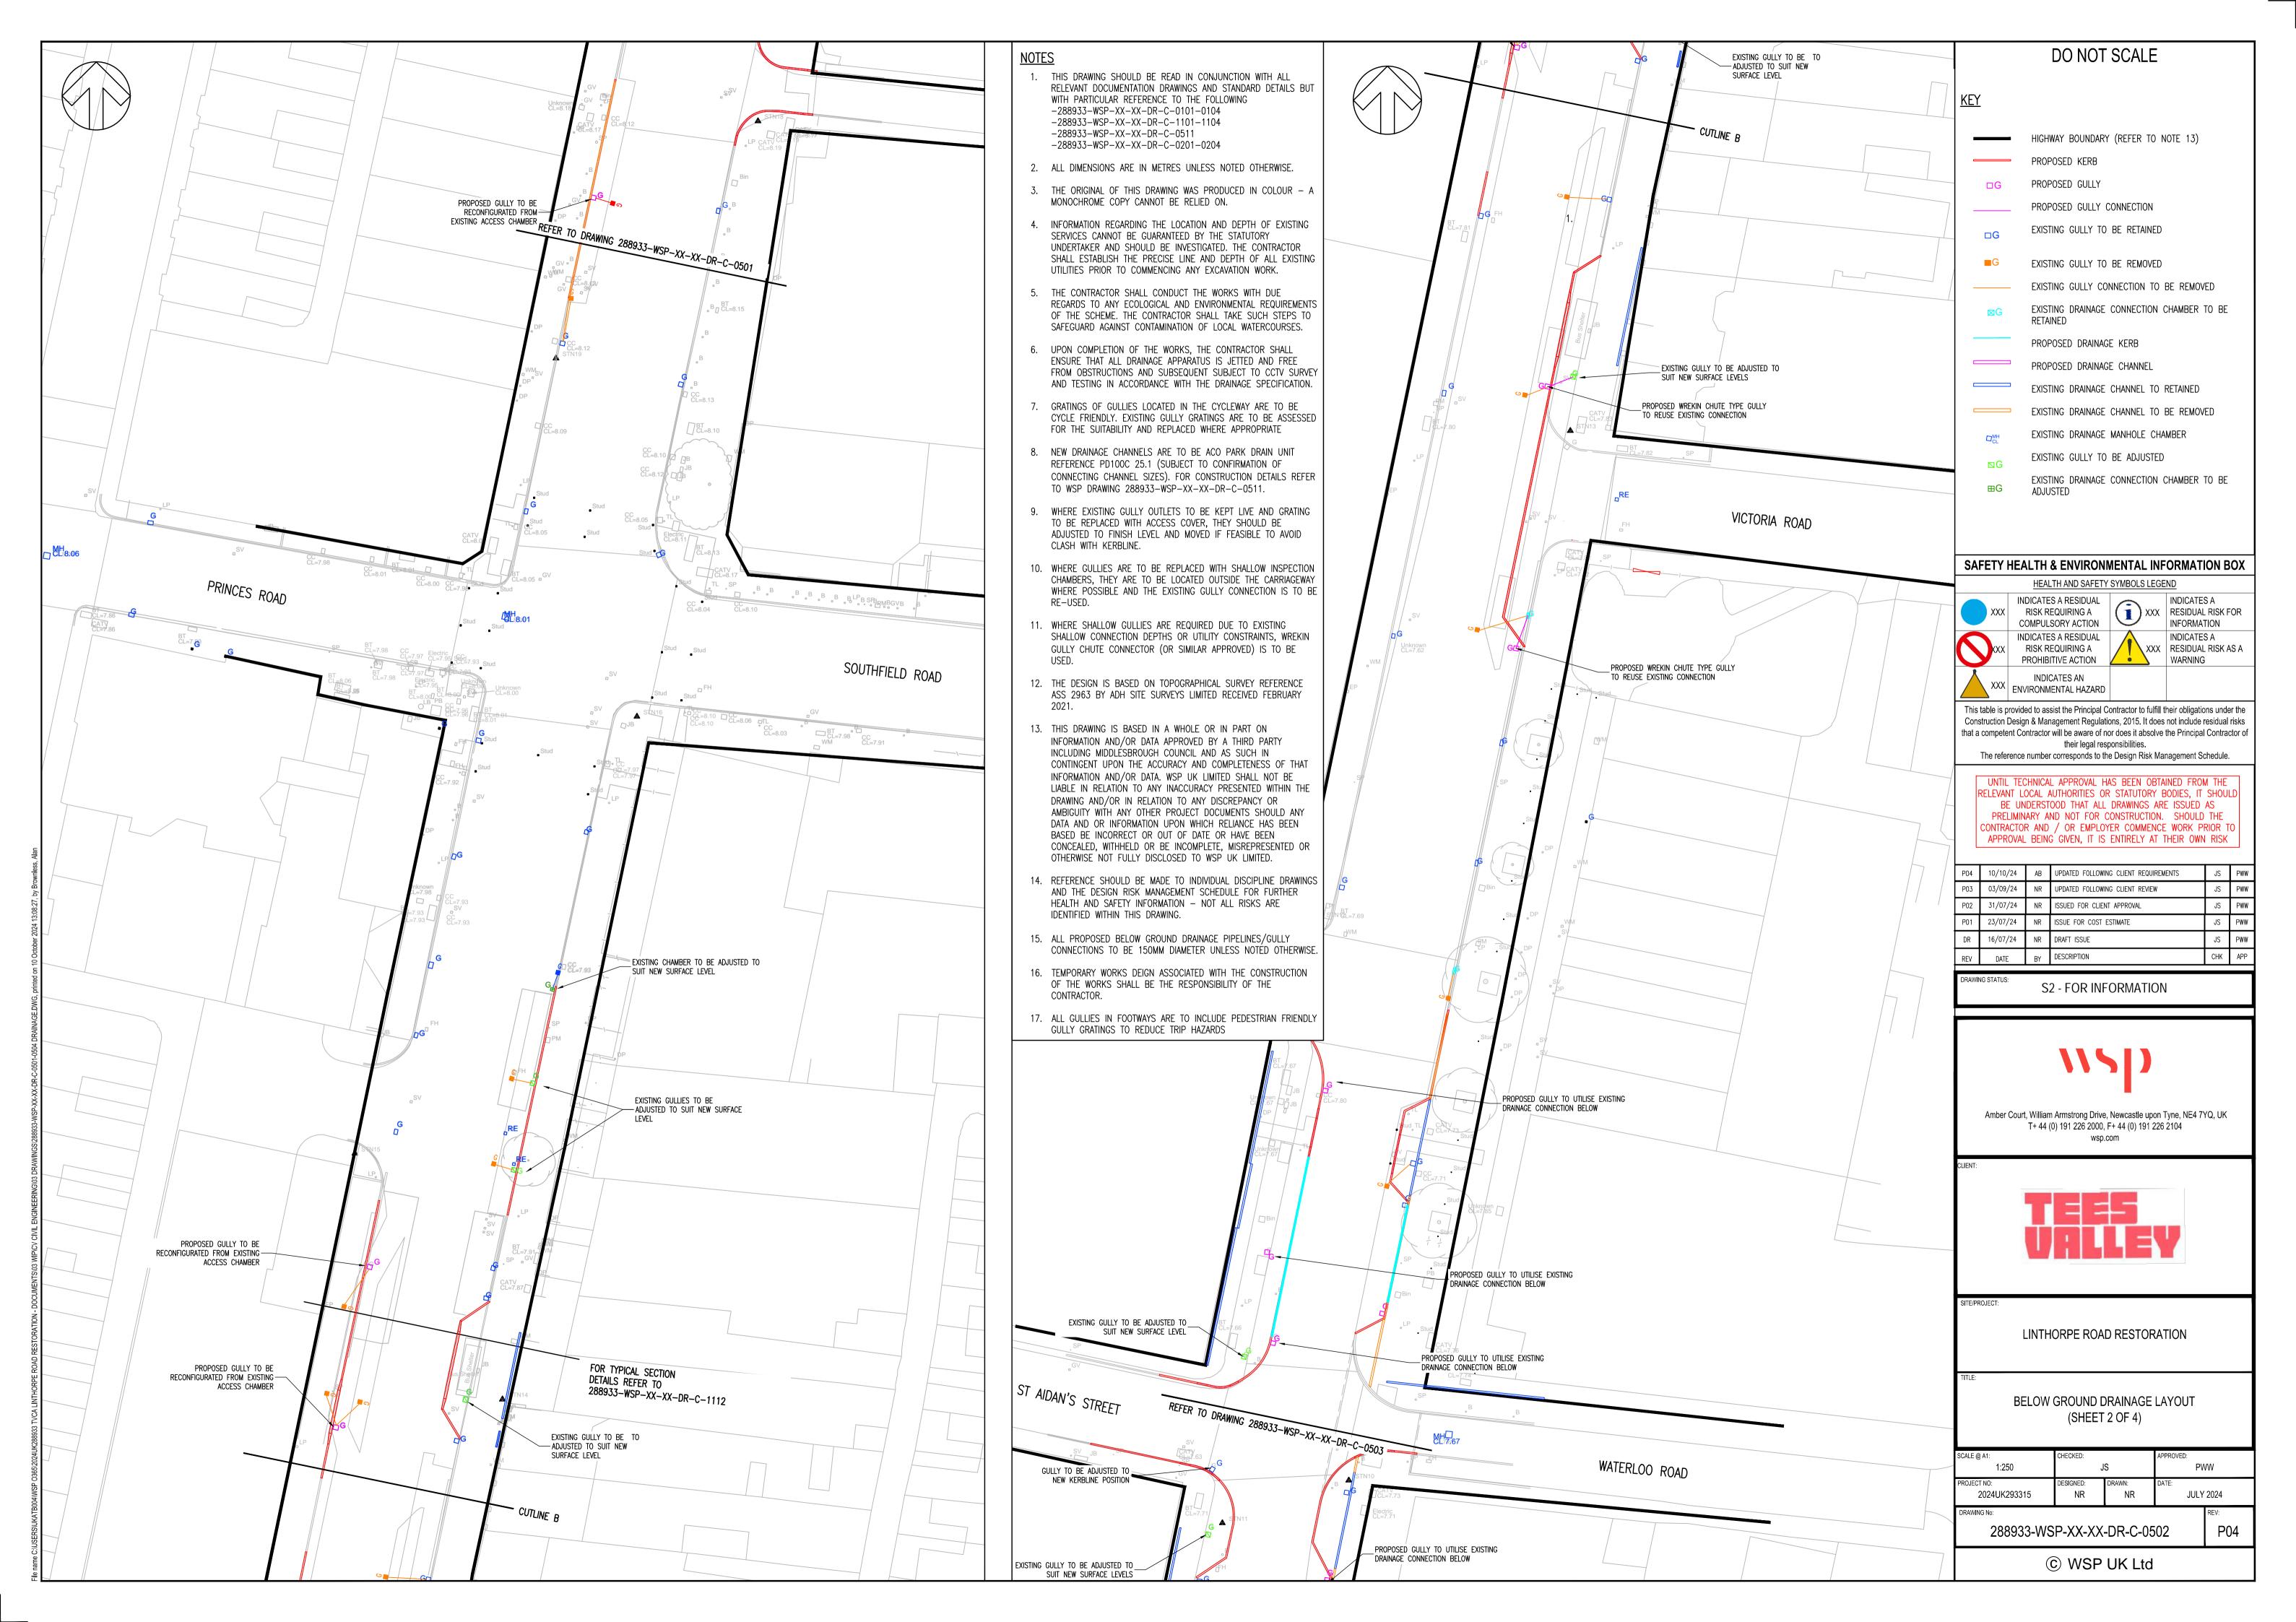

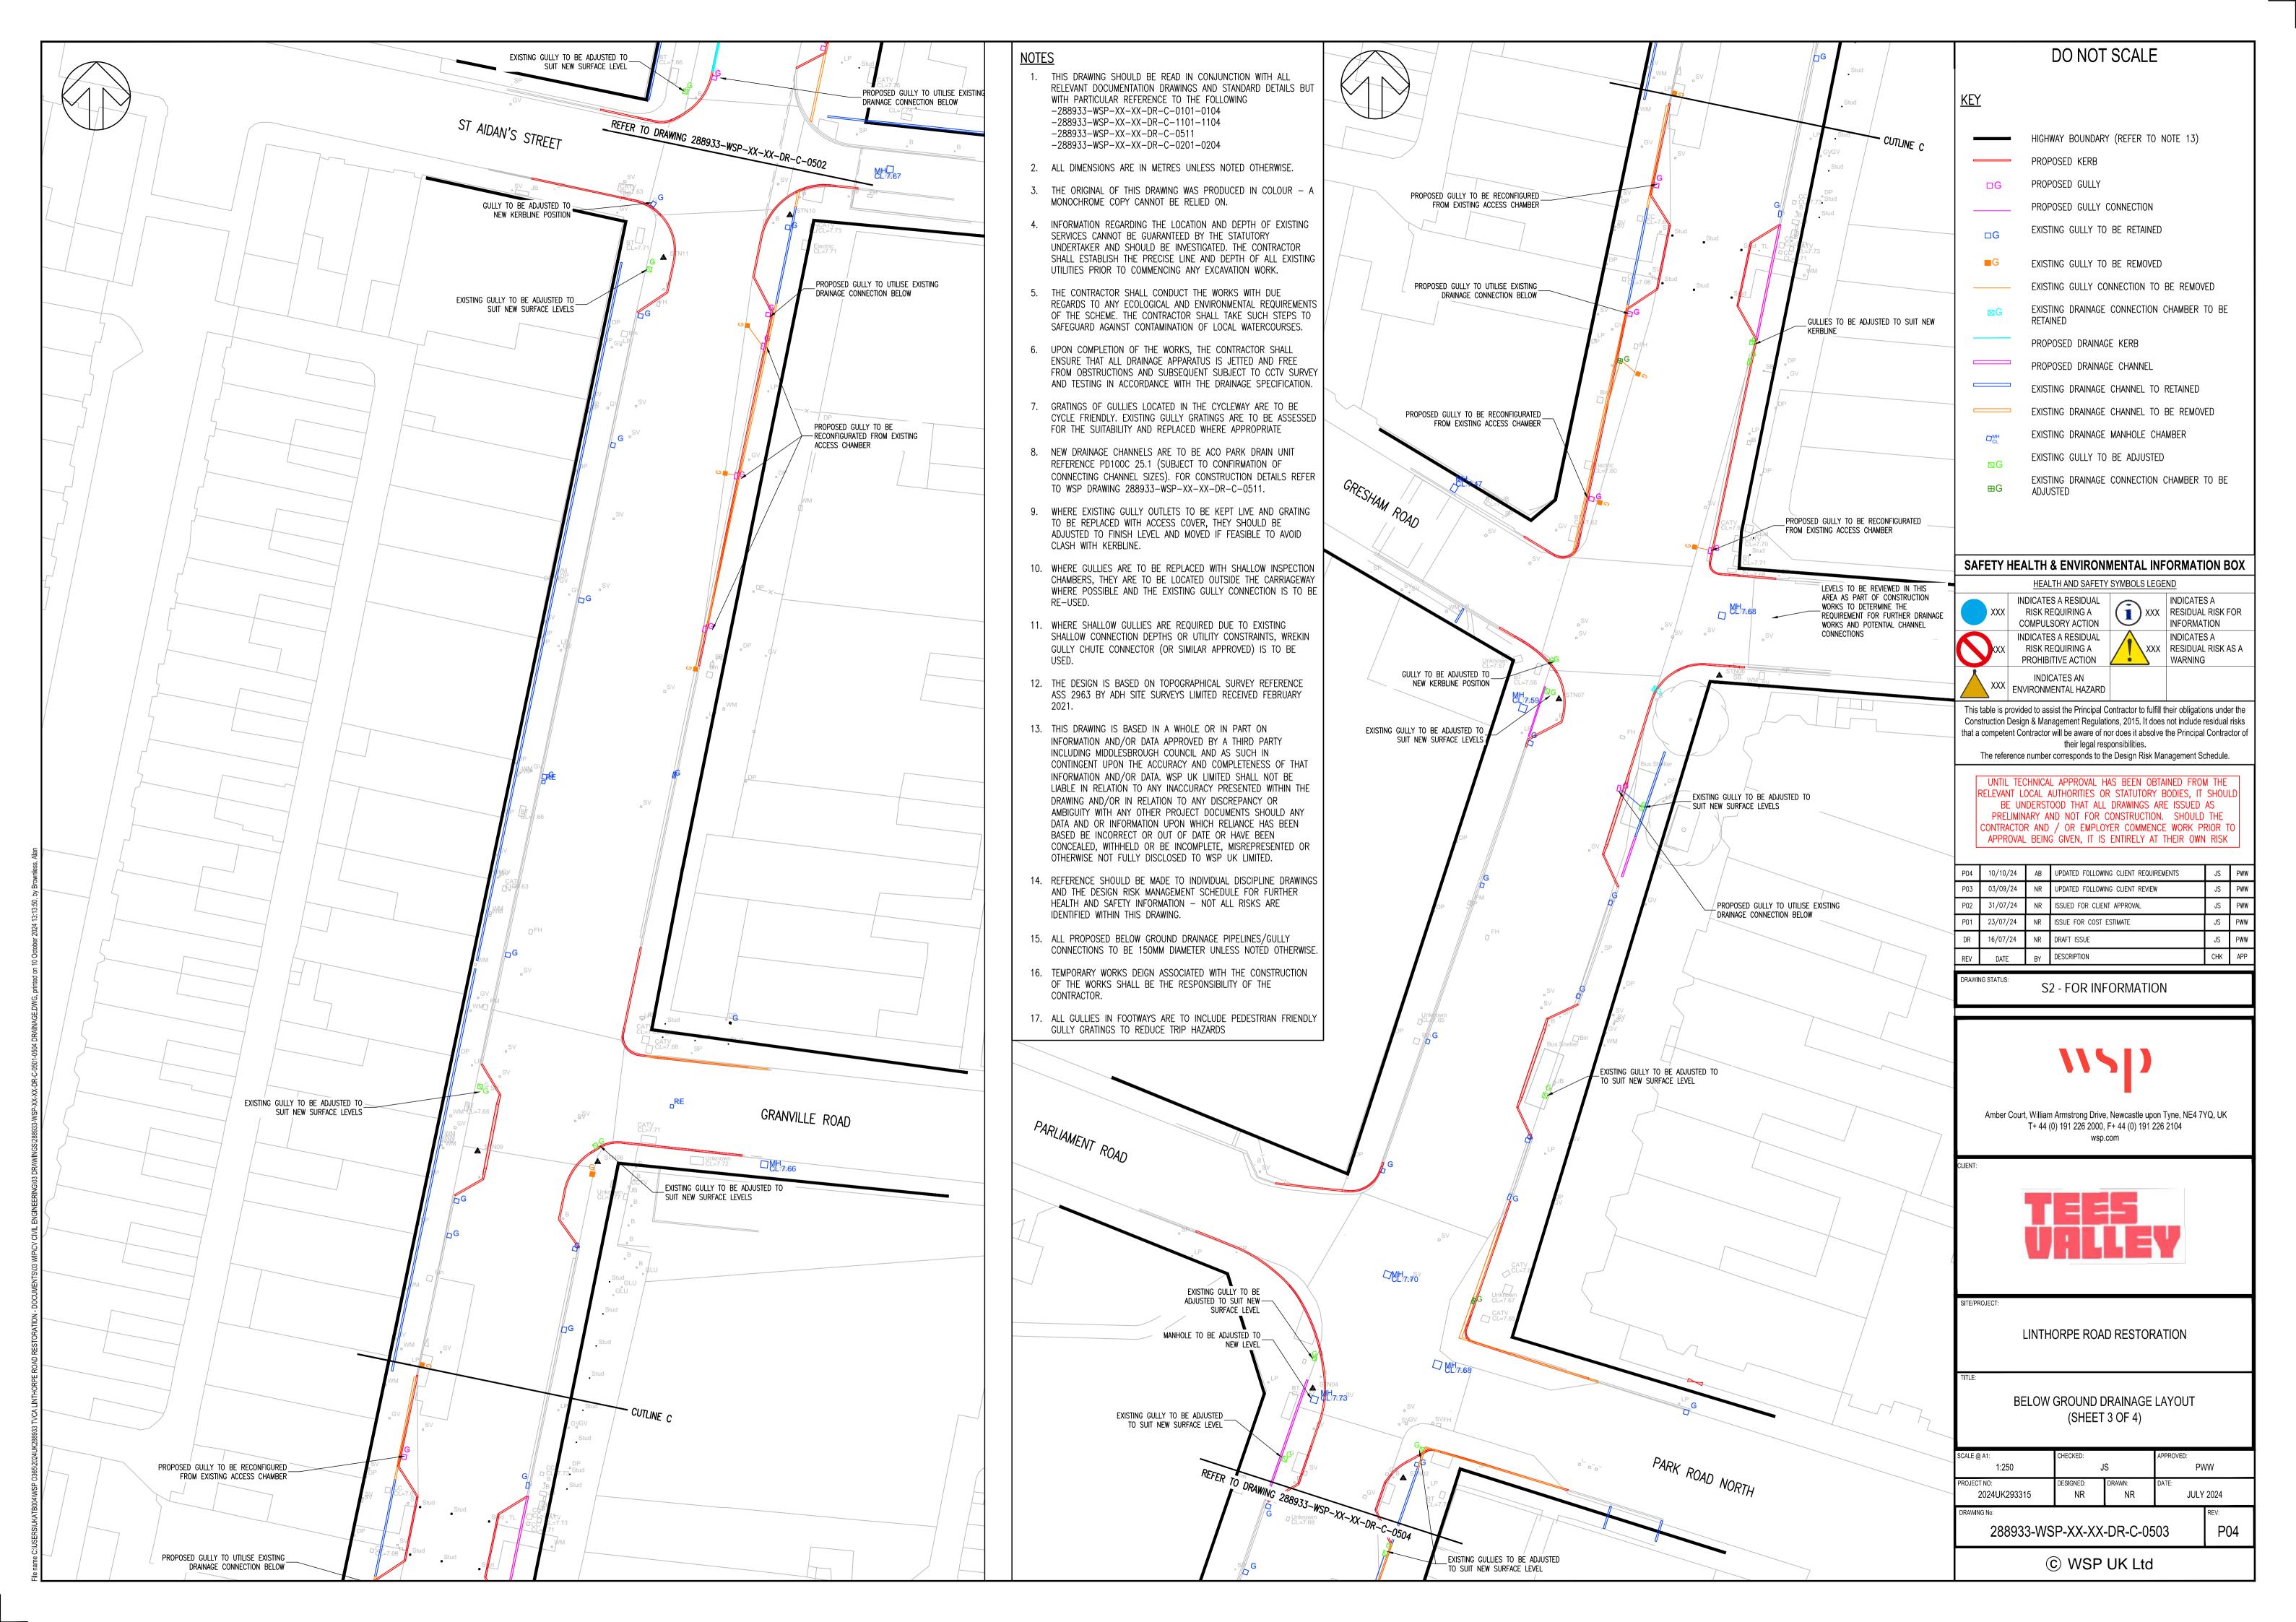

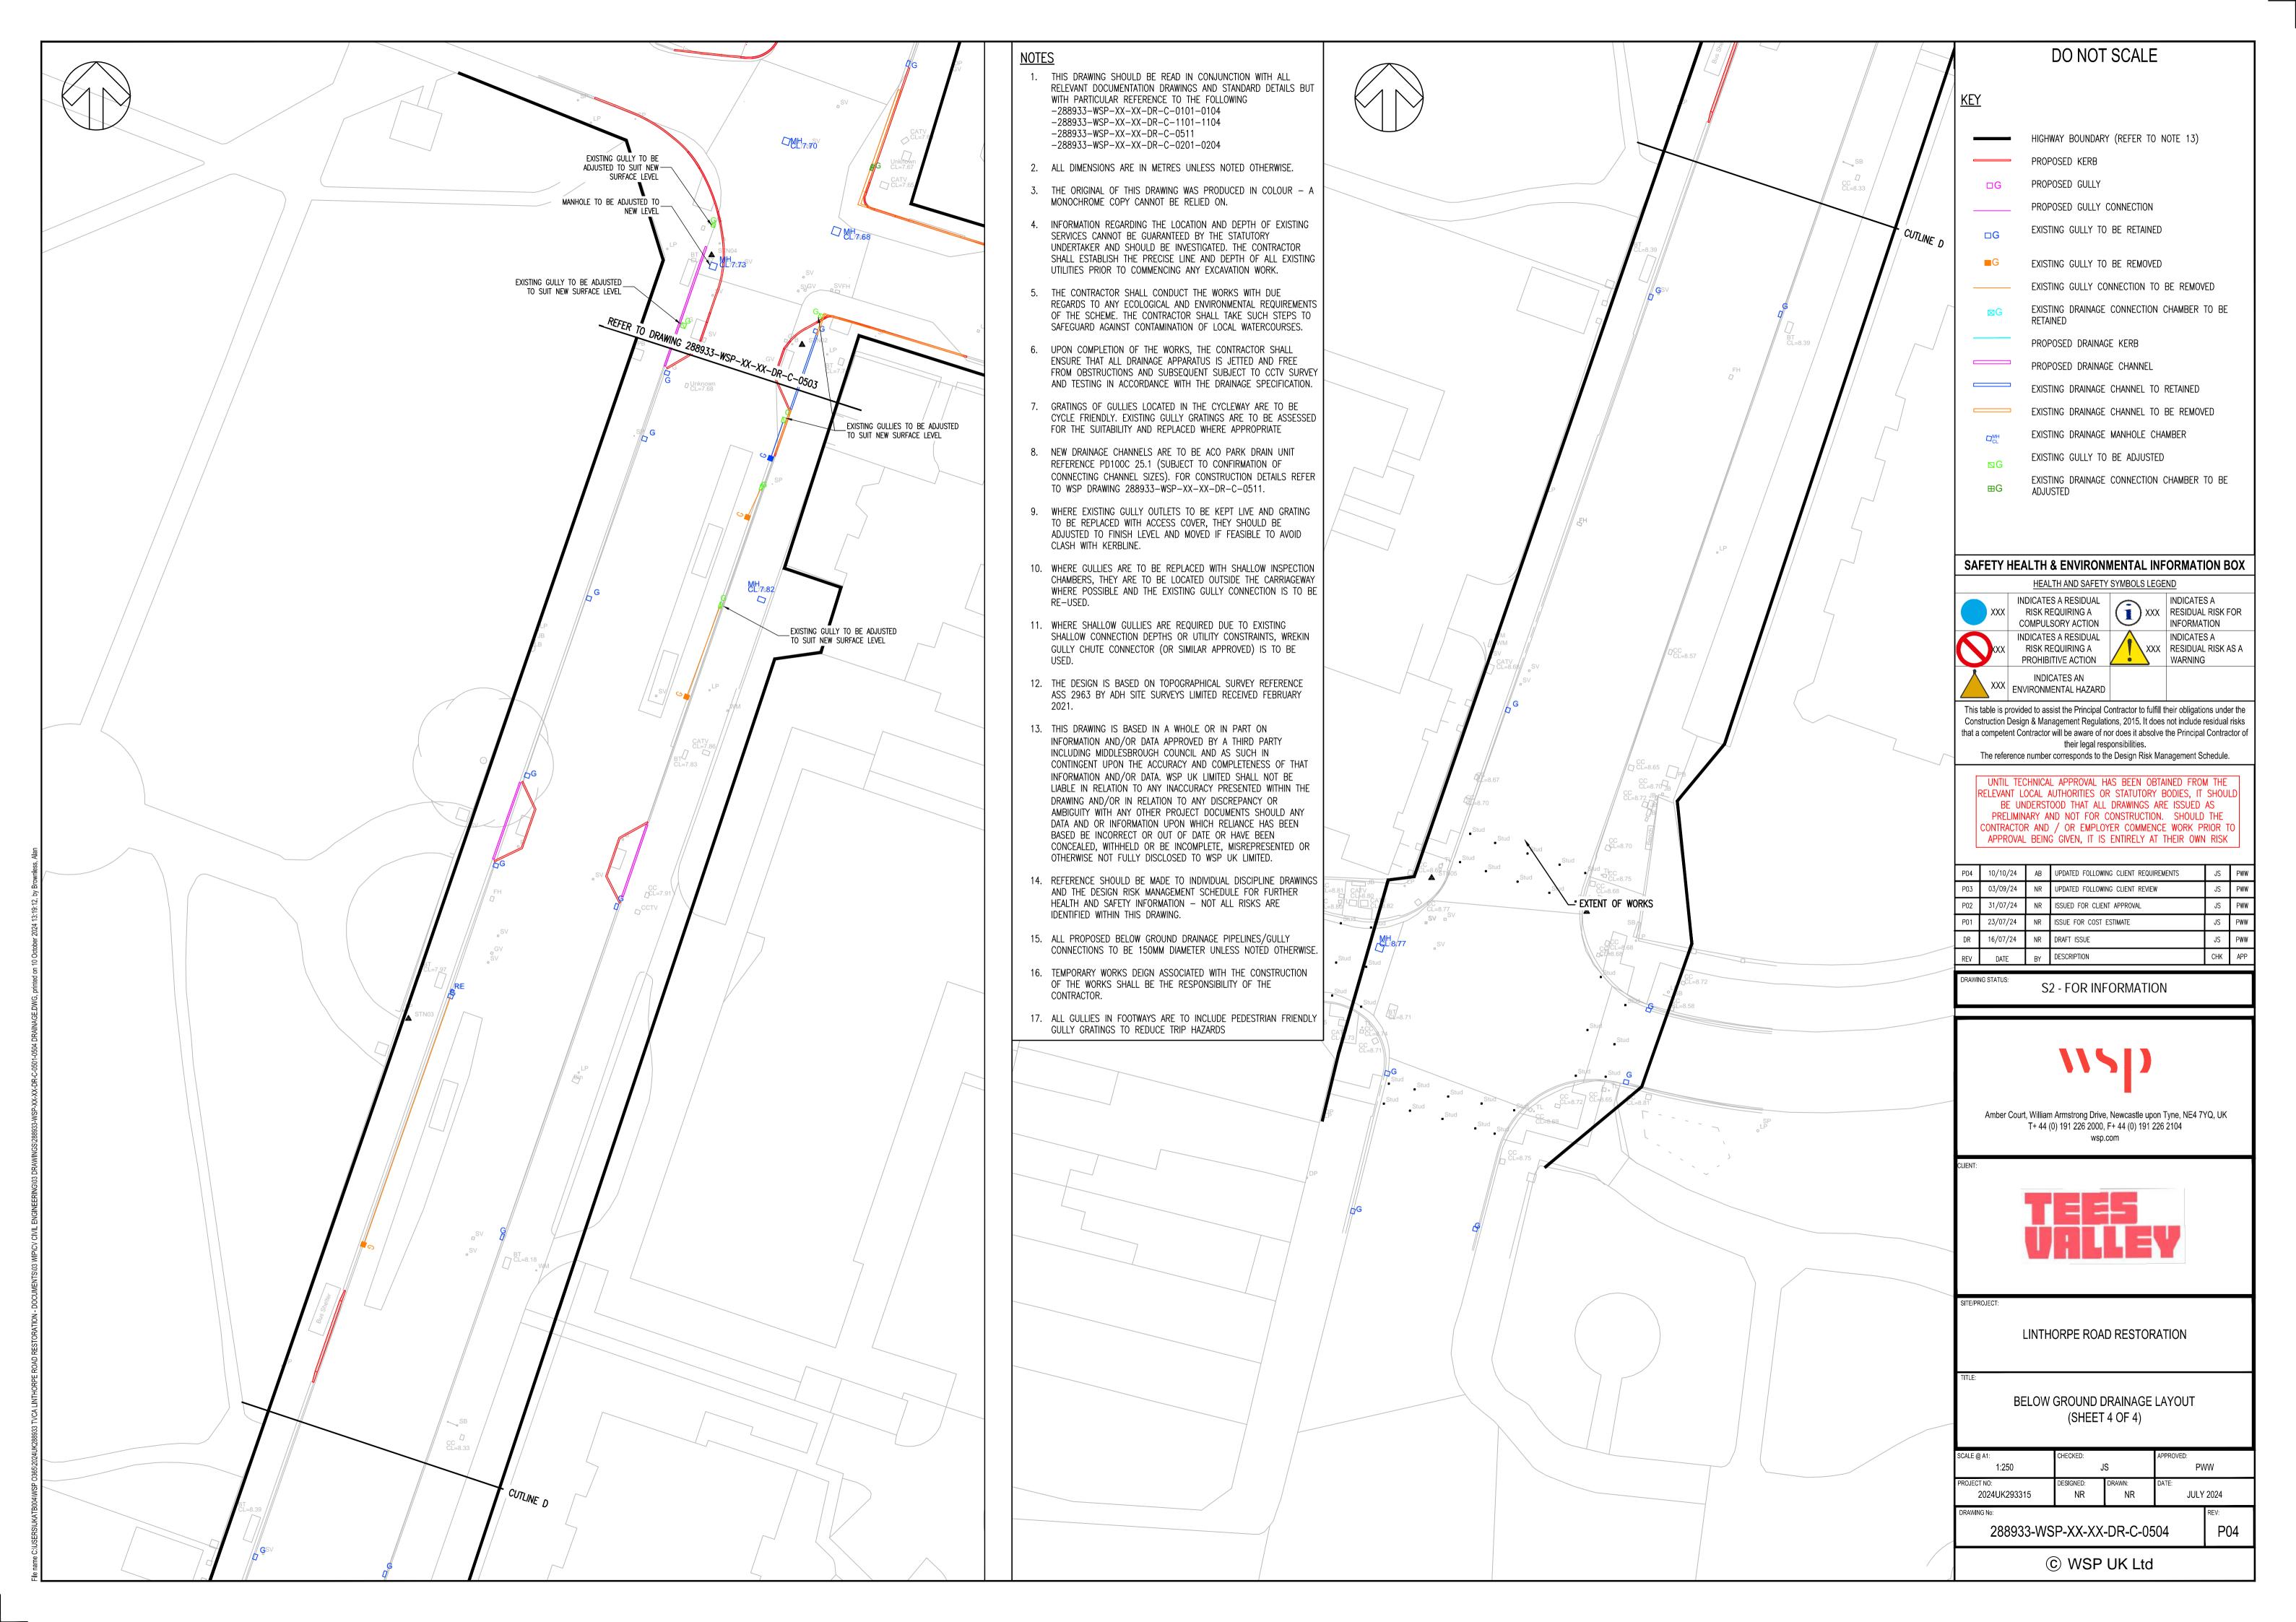

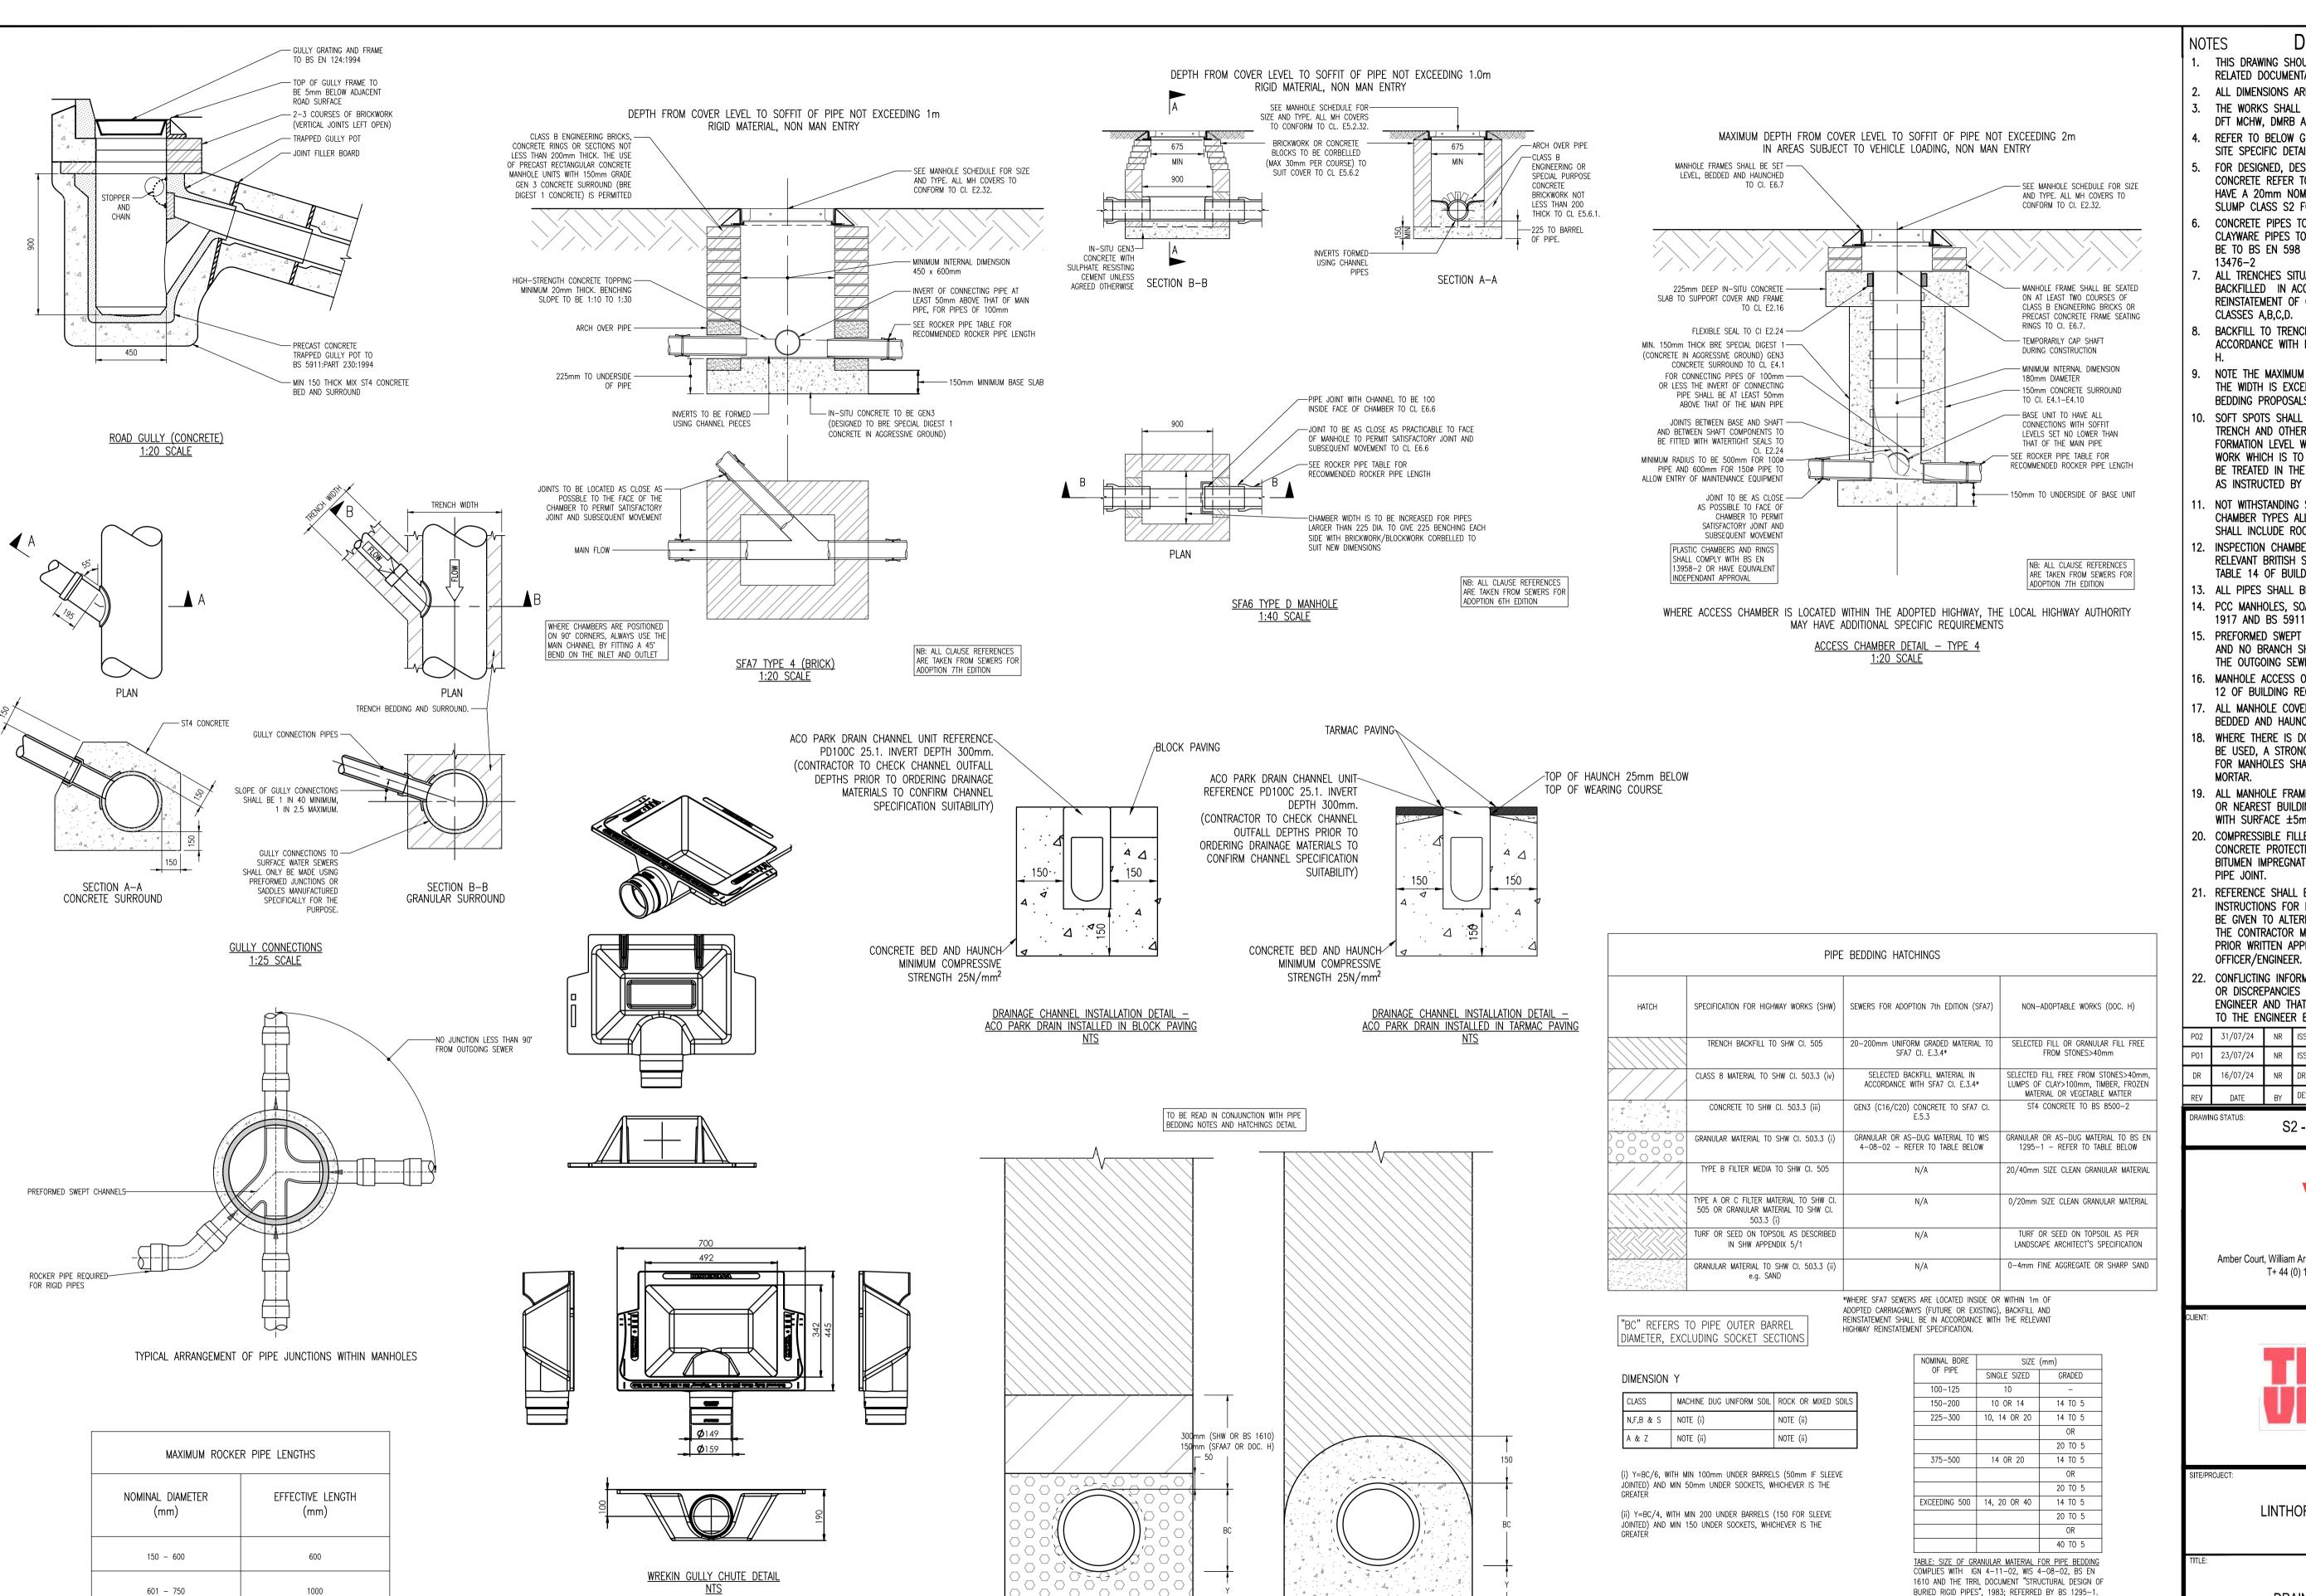

BC+300 MIN BC+600 MAX

TYPE S PIPE BEDDING

(FULL GRANULAR BED & SURROUND)

1:10 SCALE

BC+300 MIN

TYPE Z PIPE BEDDING

(FULL CONCRETE BED & SURROUND)

<u>1:10 SCALE</u>

OVER 750

PIPES BUILT INTO A STRUCTURE OR CHAMBER SHOULD HAVE A FLEXIBLE JOINT AS CLOSE AS FEASIBLE TO THE EXTERNAL FACE OF THE STRUCTURE AND THE LENGTH OF THE NEXT ROCKER

PIPE SHOULD BE AS SHOWN ABOVE

1250

UNTIL TECHNICAL APPROVAL HAS BEEN OBTAINED FROM THE RELEVANT LOCAL AUTHORITIES OR STATUTORY BODIES, IT SHOULD BE UNDERSTOOD THAT ALL DRAWINGS ARE ISSUED AS PRELIMINARY AND NOT FOR CONSTRUCTION. SHOULD THE CONTRACTOR AND / OR EMPLOYER COMMENCE WORK PRIOR TO APPROVAL BEING GIVEN, IT IS ENTIRELY AT THEIR OWN RISK

## DO NOT SCALE

- 1. THIS DRAWING SHOULD BE READ IN CONJUNCTION WITH ALL RELATED DOCUMENTATION AND DRAWINGS.
- 2. ALL DIMENSIONS ARE IN MILLIMETRES UNLESS STATED OTHERWISE
- 3. THE WORKS SHALL BE CARRIED OUT IN ACCORDANCE WITH THE
- DFT MCHW, DMRB AND MIDDLESBROUGH COUNCIL REQUIREMENTS. 4. REFER TO BELOW GROUND DRAINAGE AND LEVELS DRAWINGS FOR SITE SPECIFIC DETAILS OF DRAINAGE.
- 5. FOR DESIGNED, DESIGNATED OR STANDARDISED PRESCRIBED CONCRETE REFER TO BS EN 206-1 AND BS 8500. THEY SHALL HAVE A 20mm NOMINAL MAXIMUM SIZE OF AGGREGATE, AND A
- SLUMP CLASS S2 FOR TARGET 70mm AND NO ADMIXTURES. CONCRETE PIPES TO BE TO BS EN 1916 & BS 5911-1, CLAYWARE PIPES TO BE TO BS EN 295, DUCTILE IRON PIPES TO BE TO BS EN 598 & PLASTIC PIPES TO BS EN 13476-1 AND
- ALL TRENCHES SITUATED WITHIN TRAFFICKED AREAS TO BE BACKFILLED IN ACCORDANCE WITH HAUC SPECIFICATION FOR THE REINSTATEMENT OF OPENINGS IN HIGHWAYS APPENDIX A1
- CLASSES A,B,C,D. BACKFILL TO TRENCHES TO BE SELECTED AS-DUG MATERIAL IN ACCORDANCE WITH BUILDING REGULATIONS APPROVED DOCUMENT
- 9. NOTE THE MAXIMUM TRENCH WIDTH MUST NOT BE EXCEEDED. IF
- THE WIDTH IS EXCEEDED THE CONTRACTOR MUST SUBMIT REVISED BEDDING PROPOSALS TO THE SUPERVISING OFFICER/ENGINEER. 10. SOFT SPOTS SHALL BE REMOVED FROM THE BOTTOM OF THE
- TRENCH AND OTHER EXCAVATIONS AND THEN BE REFILLED TO FORMATION LEVEL WITH THE SAME MATERIAL AS THE PERMANENT WORK WHICH IS TO REST ON THAT FORMATION. OVERDIG SHALL BE TREATED IN THE SAME MANNER AT CONTRACTORS EXPENSE AS INSTRUCTED BY THE SUPERVISING OFFICER/ENGINEER.
- 11. NOT WITHSTANDING SPECIFIC REQUIREMENTS FOR INDIVIDUAL CHAMBER TYPES ALL PIPES LEADING TO AND FROM CHAMBERS SHALL INCLUDE ROCKER PIPES.
- 12. INSPECTION CHAMBERS SHALL BE IN ACCORDANCE WITH THE RELEVANT BRITISH STANDARD FOR THEIR MATERIAL, AS STATED IN TABLE 14 OF BUILDING REGULATIONS APPROVED DOCUMENT H.
- 13. ALL PIPES SHALL BE LAID SOFFIT TO SOFFIT UNO.
- 14. PCC MANHOLES, SOAKAWAYS & COVER SLABS TO BE BS EN 1917 AND BS 5911-3.
- 15. PREFORMED SWEPT CHANNELS SHALL BE USED AT JUNCTIONS AND NO BRANCH SHALL ENTER AT LESS THAN 90 DEGREES FROM THE OUTGOING SEWER.
- 16. MANHOLE ACCESS OPENINGS TO BE IN ACCORDANCE WITH TABLE 12 OF BUILDING REGULATIONS APPROVED DOCUMENT H.
- 17. ALL MANHOLE COVERS SHOULD BE IN ACCORDANCE AND BE BEDDED AND HAUNCHED IN MORTAR.
- 18. WHERE THERE IS DOUBT AS TO WHICH MANHOLE COVER SHOULD BE USED, A STRONGER CLASS SHOULD BE SELECTED. FRAMES
- FOR MANHOLES SHALL BE BEDDED IN CLASS M1 BEDDING 19. ALL MANHOLE FRAMES TO BE SET PARALLEL TO ADJACENT KERBS OR NEAREST BUILDINGS AND COVERS AND FRAMES TO BE FLUSH
- WITH SURFACE ±5mm MAX. 20. COMPRESSIBLE FILLER TO PIPELINES TO BE USED TO INTERRUPT CONCRETE PROTECTION TO PIPELINES AND SHALL CONSIST OF BITUMEN IMPREGNATED INSULATING BOARD TO BS 1142 AT EACH
- 21. REFERENCE SHALL BE MADE TO THE MANUFACTURER'S INSTRUCTIONS FOR PROPRIETARY PRODUCTS. CONSIDERATION WILL BE GIVEN TO ALTERNATIVE PRODUCTS OF EQUAL QUALITY BUT THE CONTRACTOR MAY NOT USE A SUBSTITUTE MATERIAL WITHOUT PRIOR WRITTEN APPROVAL OF THE SUPERVISING
- 22. CONFLICTING INFORMATION SHOWN ON THE ENGINEER'S DRAWINGS OR DISCREPANCIES BETWEEN THE INFORMATION GIVEN BY THE ENGINEER AND THAT PROVIDED BY OTHERS MUST BE REFERRED TO THE ENGINEER BEFORE THE WORKS COMMENCE.

P02	31/07/24	NR	ISSUED FOR CLIENT APPROVAL	JS	PWW
P01	23/07/24	NR	ISSUE FOR COSTING	JS	PWW
DR	16/07/24	NR	DRAFT ISSUE	JS	PWW
REV	DATE	BY	DESCRIPTION	CHK	APP

S2 - FOR INFORMATION



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LINTHORPE ROAD RESTORATION


DRAINAGE TYPICAL DETAILS


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NTS	J	S	PWW
PROJECT NO:	DESIGNED:	DRAWN:	DATE:
2024UK293315	NR	NR	JULY 2024


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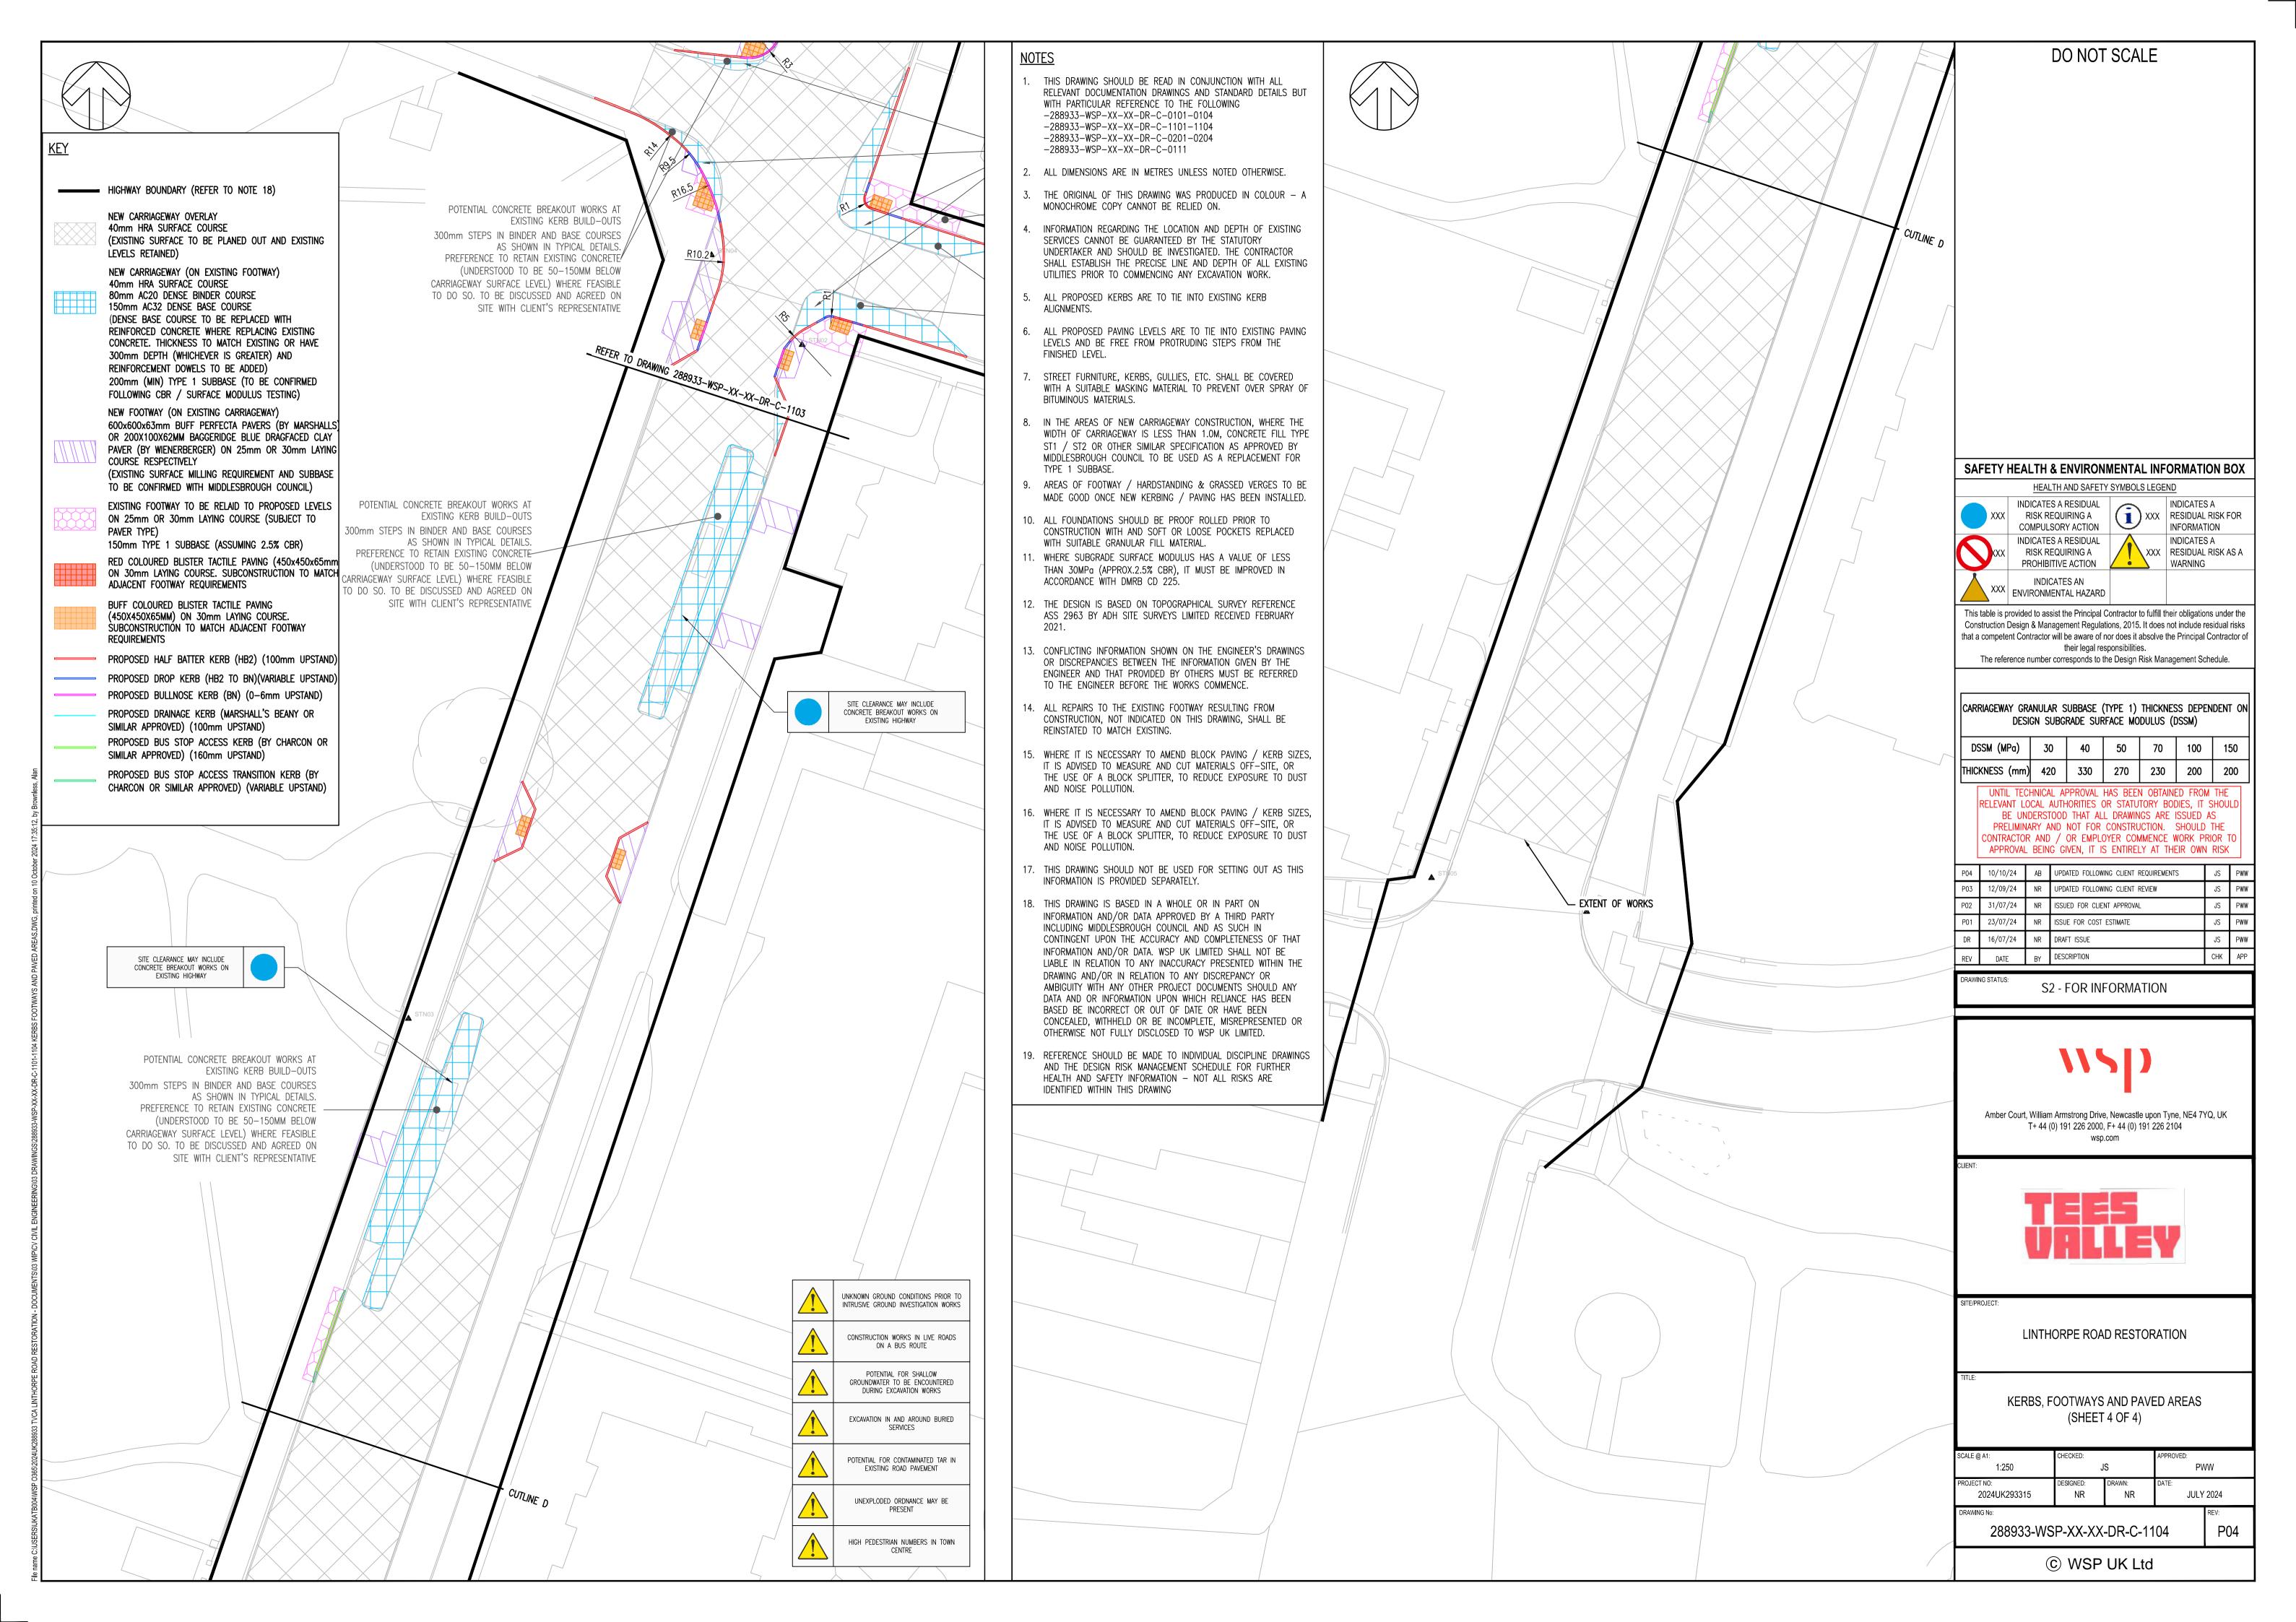
P02


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1:10 SCALE

25mm MORTAR CEMENT/SAND RATIO 1:3

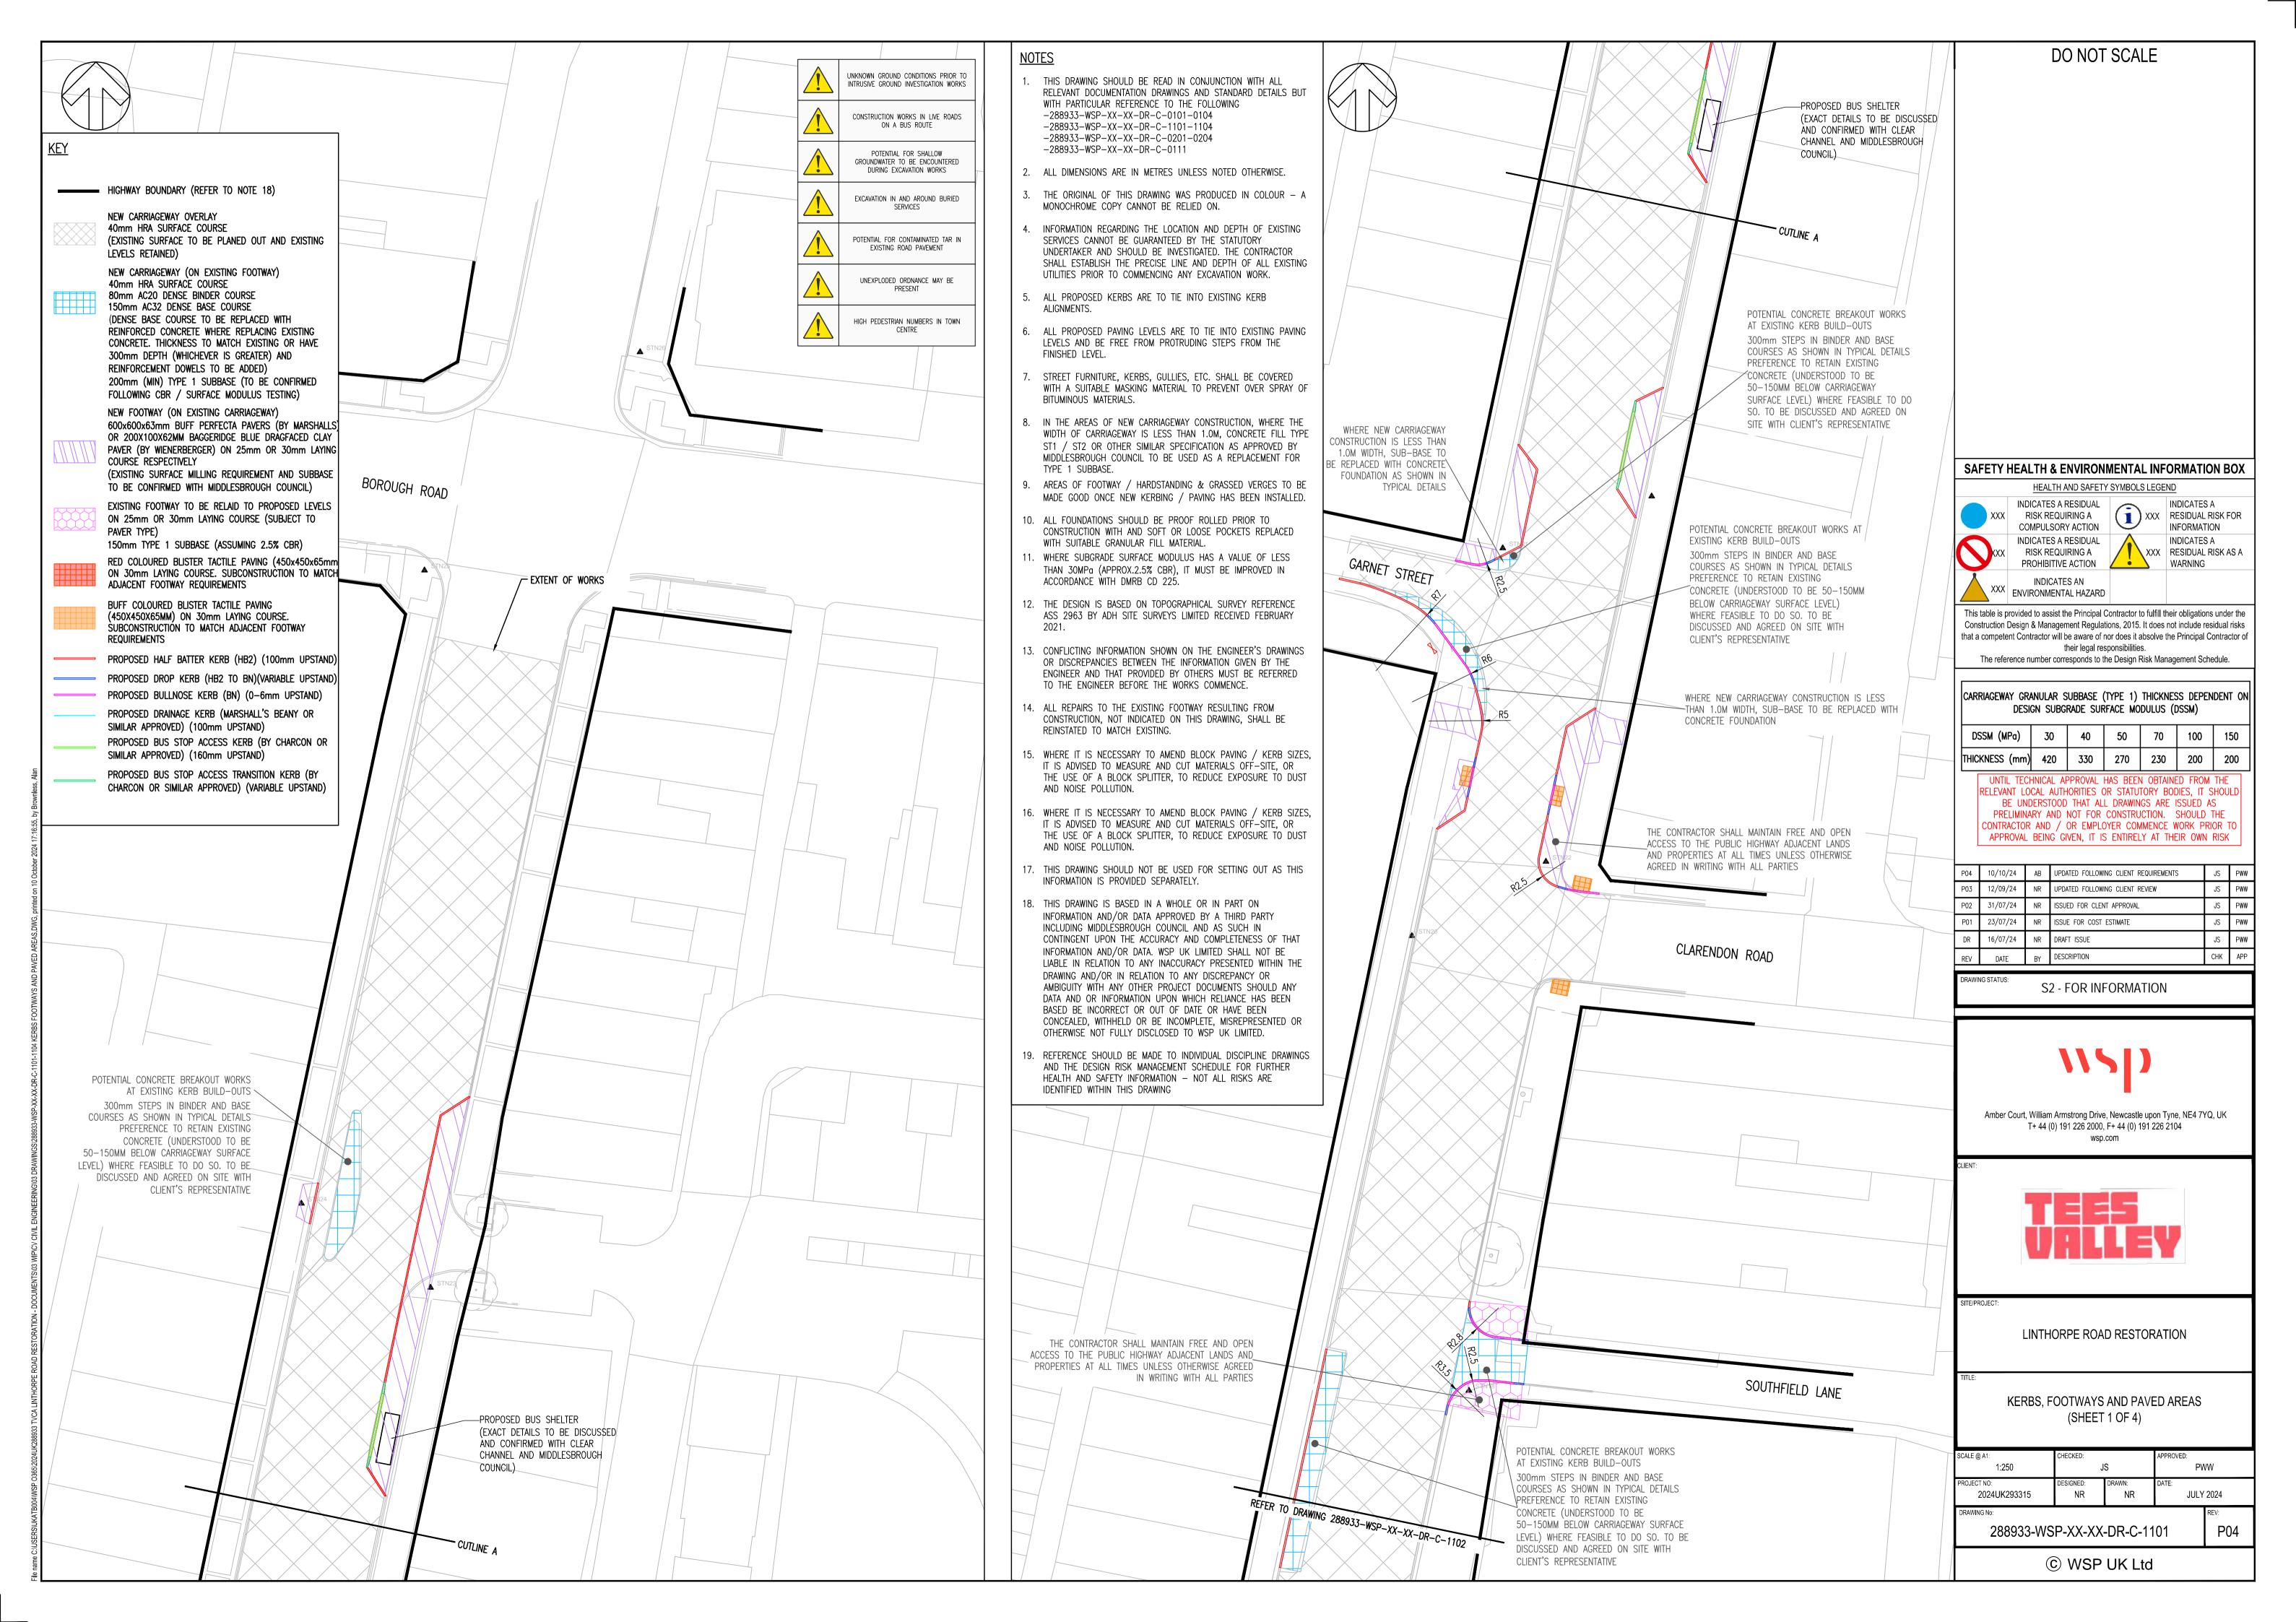450mm x 450mm x 65mm THICK
PRECAST CORDUROY PAVING SLAB
TO DFT DOCUMENT "CUIDANCE ON
THE USE OF TACTILE PAVING
SURFACES" 2002.

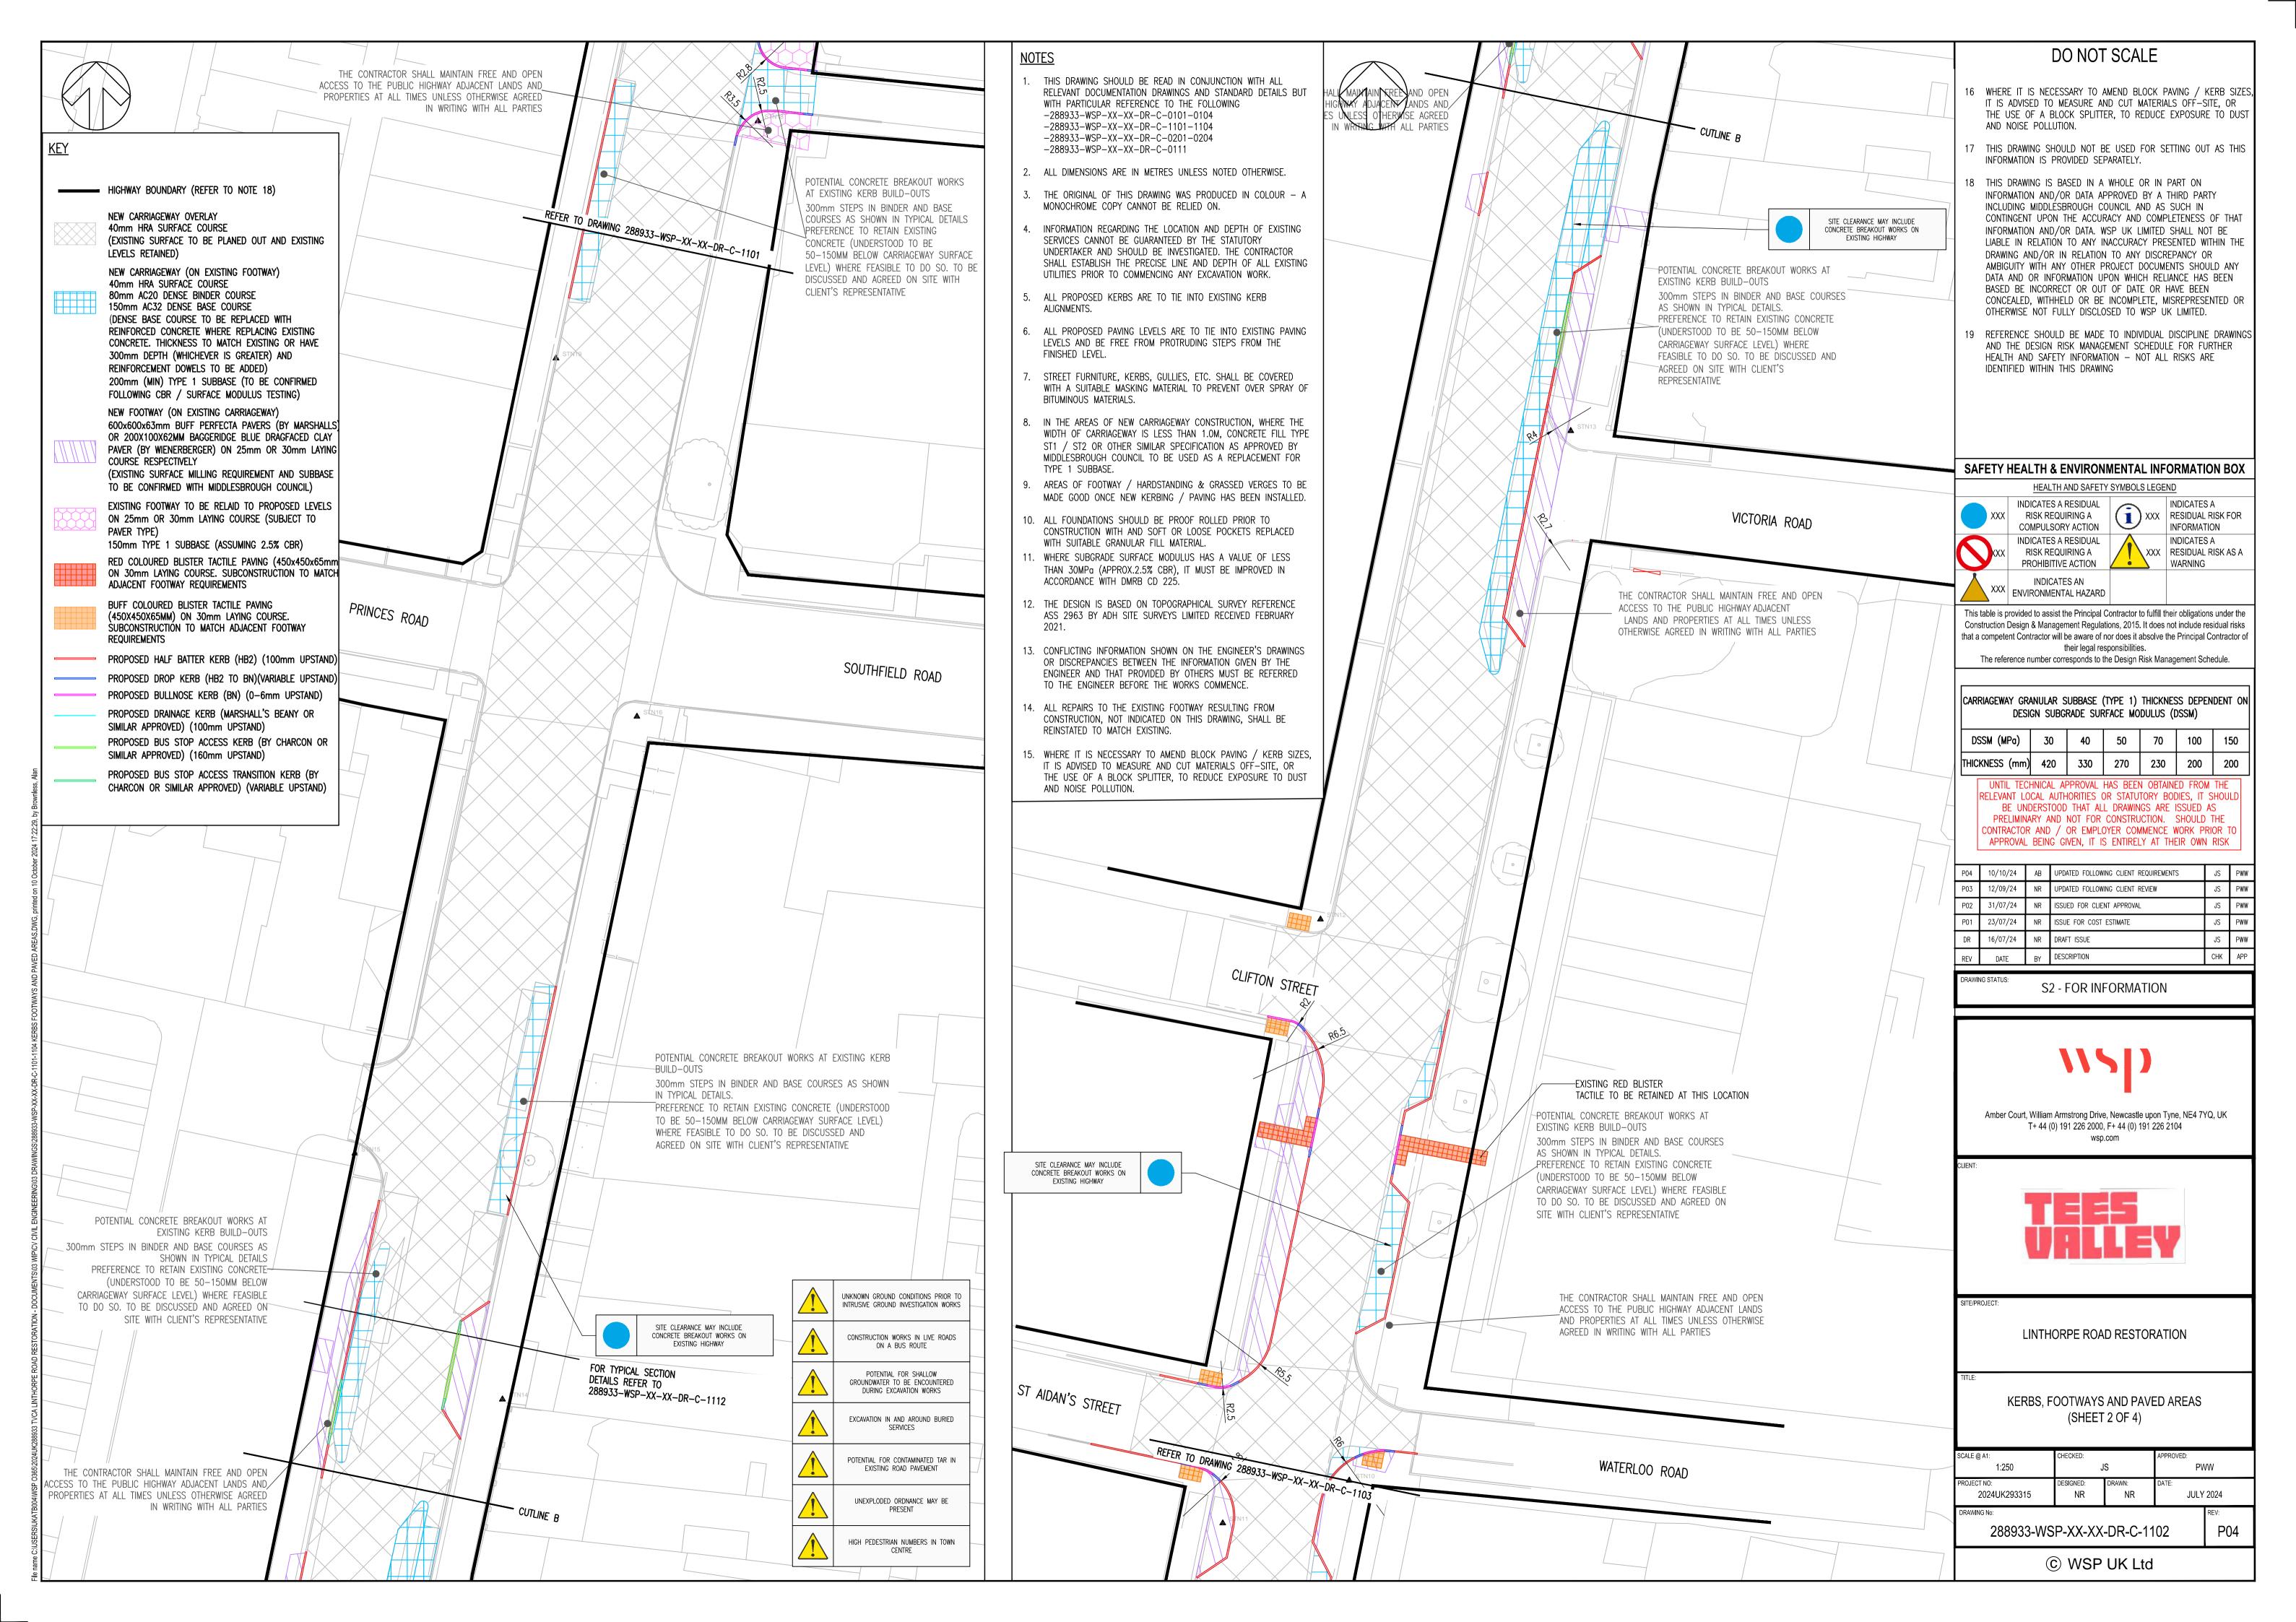TACTILE PAVING — CORDUROY SLAB UNITS (HAZARD WARNING)
1:10 SCALE

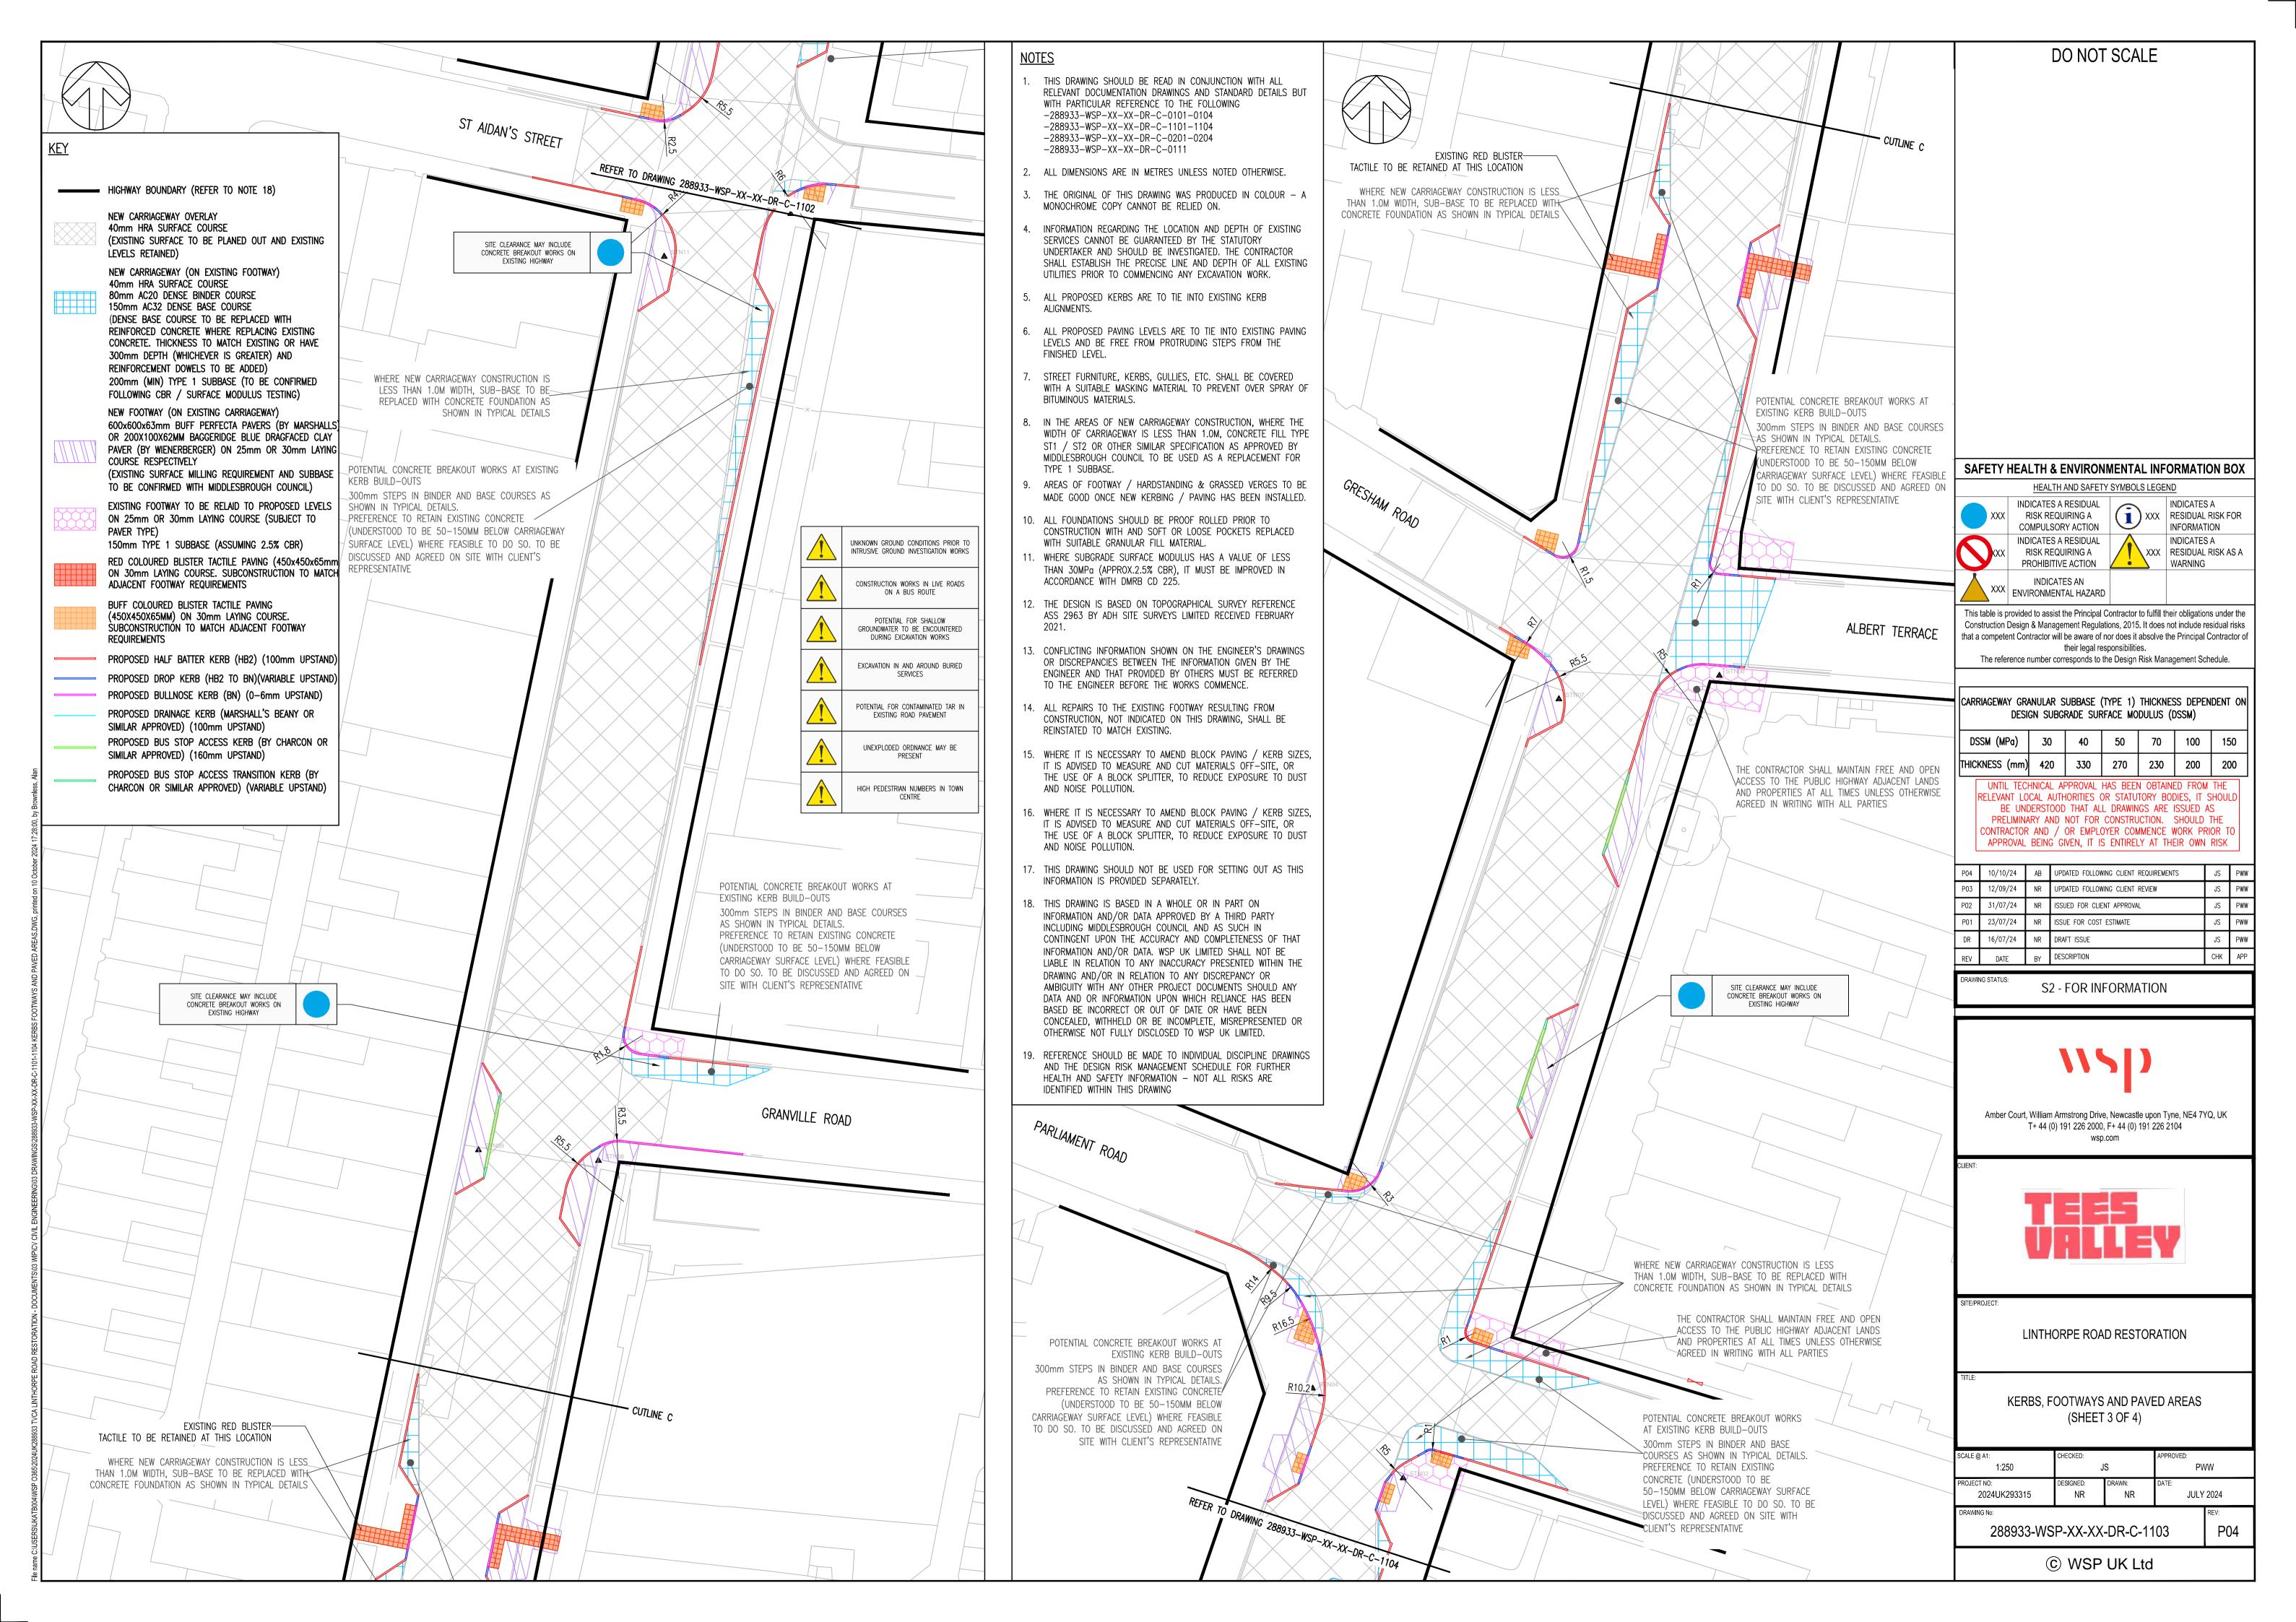TACTILE PAVING — BLISTER SLAB UNITS

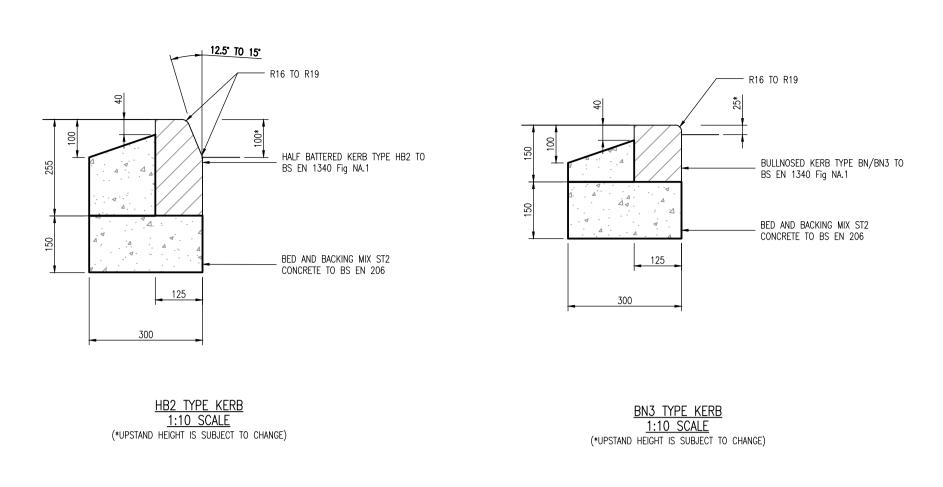25mm MORTAR CEMENT/SAND RATIO 1:3 —

450mm X 450mm X 65mm THICK — PRECAST BLISTER PAVING SLAB TO

DFT DOCUMENT "GUIDANCE ON THE

USE OF TACTILE PAVING SURFACES"

S0x200 EF KERB, 150mm\*
ABOVE CHANNEL LEVEL

BN KERB, WIDTH VARIES. 25mm UPSTAND
(6mm FOR PEDESTRIANS)

CARRIAGEWAY CHANNEL LEVEL


BN KERB, WIDTH VARIES. 25mm UPSTAND
(6mm FOR PEDESTRIANS)

ELEVATION

TYPICAL DROP KERB ARRANGEMENT

1:50 SCALE

(\*DIMENSIONS TO BE ADJUSTED TO SUIT SITE LAYOUT/DESIGN. REFER TO EXTERNAL WORKS DESIGN LAYOUTS AND SPECIFICATION)

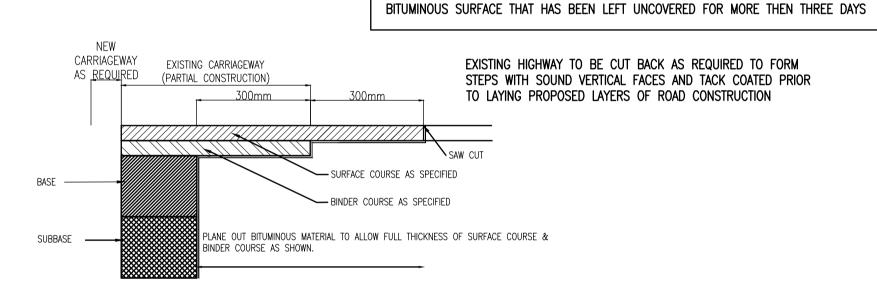


PRIOR TO LAYING SUBSEQUENT LAYERS OF BITUMOUS MATERIAL THE SURFACE SHALL BE

THOROUGHLY CLEANED AND A TACK COAT OF BITUMEN EMULSION CLASS K1-40 TO BS434 SHALL BE APPLIED AT A RATE OF 0.4 TO 0.6 LITRES PER SQUARE METRE TO ANY


ROAD PAVEMENT TIE—IN CONSTRUCTION

NARROW WIDTHS

(SCALE 1:10)

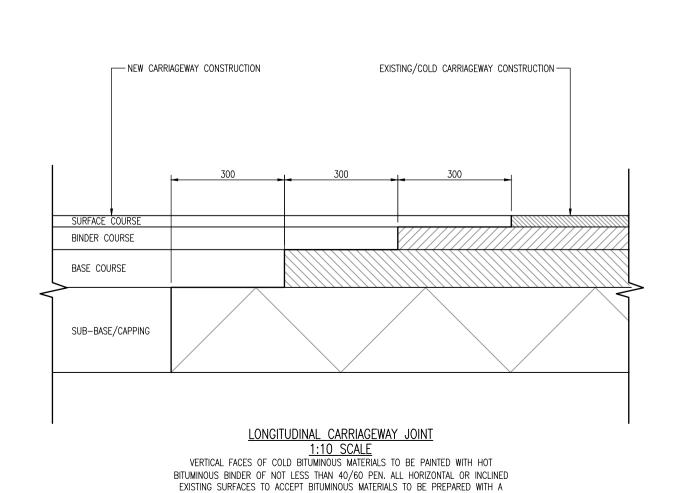

BOND COAT IN ACCORDANCE WITH BS 594987

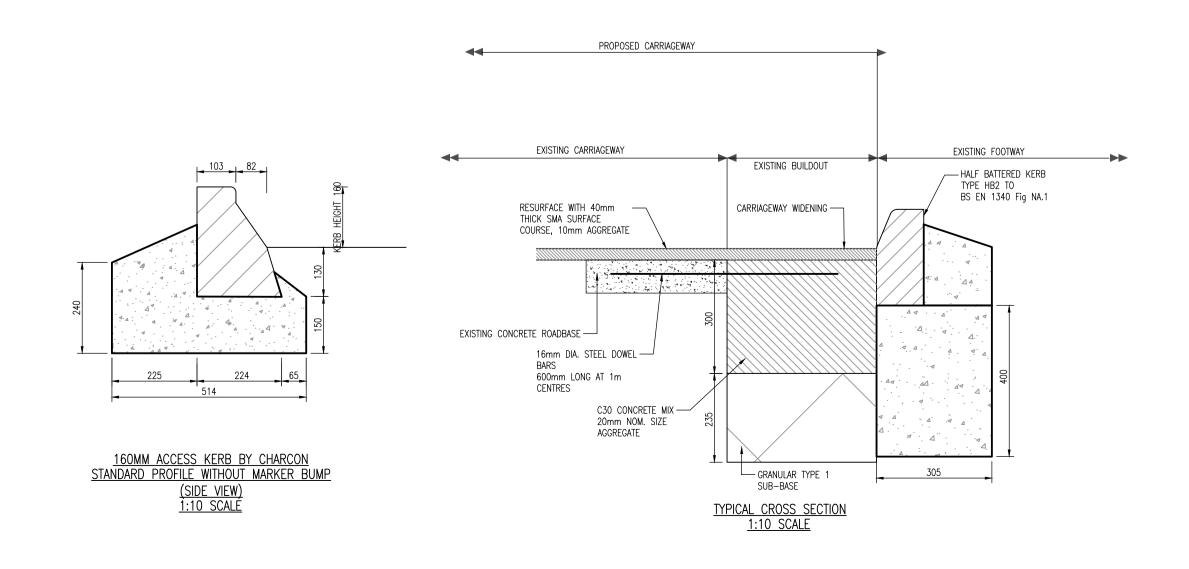

NOTES

- 1. THIS DRAWING SHOULD BE READ IN CONJUNCTION WITH ALL RELATED DOCUMENTATION AND DRAWINGS.
- 2. ALL DIMENSIONS ARE IN MILLIMETRES UNLESS STATED OTHERWISE.
- 3. THE WORKS SHALL BE CARRIED OUT IN ACCORDANCE WITH THE DFT MCHW, DMRB AND MIDDLESBROUGH COUNCIL REQUIREMENTS.
- 4. REFER TO THE KERBS, FOOTWAYS AND PAVED AREAS DRAWINGS FOR SITE SPECIFIC DETAILS OF KERBING AND SURFACING
- 5. KERBS TO BE BUTT JOINTED. WHERE KERB ALIGNMENTS INCUR MINOR OPEN JOINT TAPERS IN EXCESS OF 5mm BETWEEN

FORMED SURFACES, MORTAR JOINTING SHALL BE USED.

- 6. FULL LENGTH PCC KERBS ARE TO BE MECHANICALLY HANDLED.
- 7. ALL PRECAST KERBS, CHANNELS AND EDGINGS SHALL BE TO BS EN 1340 AND LAID TO BS 7533-6 AND ALL SETTS OF NATURAL STONE SHALL BE TO BS EN 1342 AND LAID TO BS 7533-7.
- 8. ALL KERBS, CHANNELS AND EDGINGS BED & BACKING SHALL BE ST2 CONCRETE WELL COMPACTED. UNLESS OTHERWISE STATED, THIS SHALL BE A MINIMUM BED THICKNESS OF 150mm FOR KERBS AND CHANNELS, 100mm FOR EDGINGS.
- 9. THE MINIMUM CUT OF ANY LENGTH OF KERB SHALL BE 450mm.
- 10. THE CORRECT TRANSITION SHALL BE USED FOR ALL DROP KERBS AND UPSTAND VARIATION LOCATIONS.
- 11. KERBS SHALL BE LAID ON BEDDING WHILST CONCRETE IS STILL "GREEN". WHERE THE BEDDING CONCRETE HAS CURED PRIOR TO INSTALLING THE FINISHED KERBING, 20mm NOMINAL THICKNESS CEMENT MORTAR BED DESIGNATION (i) SHALL BE USED. N.B. THE MINIMUM BEDDING THICKNESS OF 150mm SHALL BE MAINTAINED.

DO NOT SCALE

- 12. TACTILE PAVING SHALL BE COLOURED RED AT CONTROLLED CROSSING POINTS AND BUFF AT UNCONTROLLED CROSSINGS.
- 13. MORTAR FOR TACTILE PAVING BE AS PER THAT SPECIFIED FOR BLOCK PAVING. CHLORIDE ION CONTENT OF MORTAR SHALL BE IN ACCORDANCE WITH BS EN 1744-1 AND SHALL NOT EXCEED 0.3% MASS OF CEMENT (0.2% FOR SULPHATE RESISTANT

CEMENT. CALCIUM CHLORIDE IS NOT ACCEPTABLE.

- 14. NO FROST-SUSCEPTIBLE MATERIALS TO BE USED WITHIN 450mm OF THE FINISHED SURFACE UNLESS EXPRESSLY REQUIRED BY THE ENGINEER.
- 15. WHERE THE TRIMMING OF BLOCKS IS NECESSARY, PORTIONS OF LESS THAN ONE THIRD OF AN ENTIRE BLOCK SHALL NOT BE LAID. INSTEAD THE PATTERN SHOULD BE ALTERED TO ENABLE LARGER PIECES OF BLOCK TO BE USED.
- 16. IF THE DEPTH OF AN ACCESS COVER FRAME PROHIBITS BLOCKS FROM BEING LAID UP CLOSE TO THE FRAME IT SHOULD BE SURROUNDED IN CONCRETE GRADE ST2 UP TO FINISHED GROUND LEVEL.
- 17. JOINTING MATERIAL SHALL BE 0.5mm DRIED FREE FLOWING SILICA TO BS 7533-3 TABLE D.4. JOINT FILLING SHALL TAKE PLACE IMMEDIATELY AFTER THE BLOCK PAVERS HAVE BEEN COMPACTED INTO THE LAYING COURSE, AND COMPLETED WITH A FINAL COMPACTION OF THE FINISHED SURFACE.
- 18. ASPHALTIC CONCRETE MATERIALS ARE TO BE IN ACCORDANCE WITH THE RELEVANT SECTION WITHIN BS EN 13108 PARTS 1-21, WITH ADDITIONAL GUIDANCE PROVIDED WITHIN PD 6691.
- 19. INSTALLATION OF ASPHALTIC SURFACES TO BE IN ACCORDANCE WITH BS 594987.
- 20. APPLICATION OF BOND COATS SHALL BE APPLIED IN COMPLIANCE WITH BS 594987 CI.5.5 AND APPLIED AT A UNIFORM RATE OF SPREAD. TACK COATS SHALL NOT BE ACCEPTED, UNLESS AGREED IN ADVANCE WITH THE ENGINEER.
- 21. COLD SURFACES OF ASPHALT AT TIE—INS TO BE CLEANED PRIOR TO APPLICATION OF BOND COAT TO ENSURE ADEQUATE COHESION OF NEW MATERIALS.
- 22. IN THE AREAS OF NEW CARRIAGEWAY CONSTRUCTION, WHERE THE WIDTH OF CARRIAGEWAY IS LESS THAN 1.0M, CONCRETE FILL TYPE ST1 / ST2 OR OTHER SIMILAR SPECIFICATION AS APPROVED BY MIDDLESBROUGH COUNCIL TO BE USED AS A REPLACEMENT FOR TYPE 1 SUBBASE.
- 23. CONFLICTING INFORMATION SHOWN ON THE ENGINEER'S DRAWINGS OR DISCREPANCIES BETWEEN THE INFORMATION GIVEN BY THE ENGINEER AND THAT PROVIDED BY OTHERS MUST BE REFERRED TO THE ENGINEER BEFORE THE WORKS COMMENCE.

UNTIL TECHNICAL APPROVAL HAS BEEN OBTAINED FROM THE RELEVANT LOCAL AUTHORITIES OR STATUTORY BODIES, IT SHOULD BE UNDERSTOOD THAT ALL DRAWINGS ARE ISSUED AS PRELIMINARY AND NOT FOR CONSTRUCTION. SHOULD THE CONTRACTOR AND / OR EMPLOYER COMMENCE WORK PRIOR TO APPROVAL BEING GIVEN, IT IS ENTIRELY AT THEIR OWN RISK

P02	31/07/24	NR	ISSUED FOR CLIENT APPROVAL	JS	PWW
P01	23/07/24	NR	ISSUE FOR COSTING	JS	PWW
DR	16/07/24	NR	DRAFT ISSUE	JS	PWW
REV	DATE	BY	DESCRIPTION	CHK	APP

S2 - FOR INFORMATION



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CLIENT:



SITE/PROJECT:


LINTHORPE ROAD RESTORATION


TYPICAL HIGHWAY DETAILS

E @ A1:	CHECKED:		APPROVED:
NTS	JS		PWW
ECT NO: 2024UK293315	DESIGNED: NR	DRAWN: NR	DATE: JULY 2024


288933-WSP-XX-XX-DR-C-1111


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TYPICAL SECTION 2-2 1:100

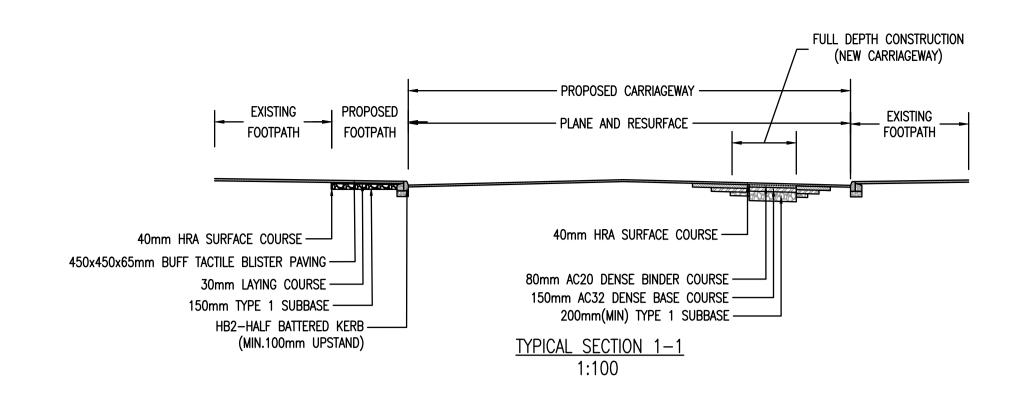

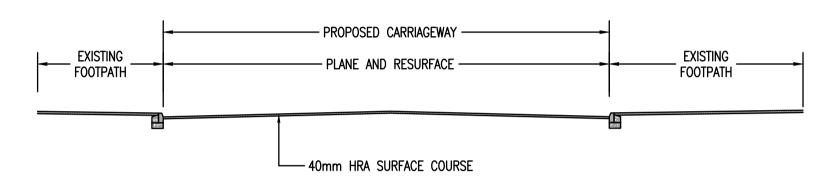

TYPICAL SECTION 4-4 1:100
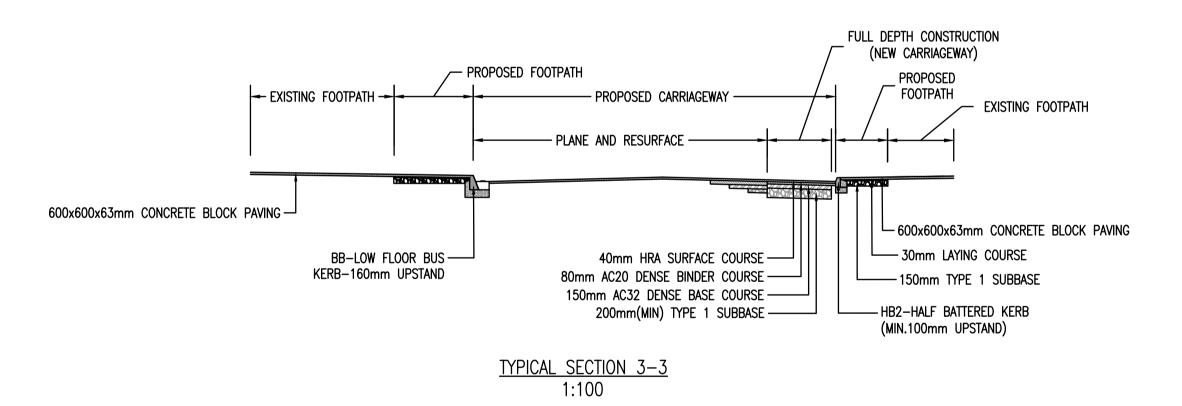
### DO NOT SCALE

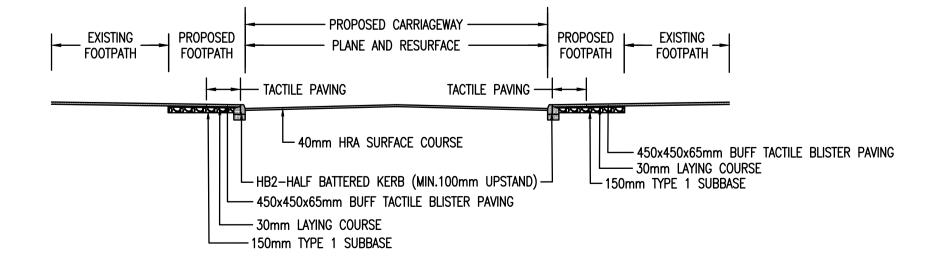- I. ALL DIMENSIONS ARE IN METRES UNLESS NOTED OTHERWISE.
- 2. FOR SECTION LOCATIONS , REFER DRAWING NO. 288933-WSP-XX-XX-DR-C-000101 - 000104.
- . THIS DRAWING SHOULD BE READ IN CONJUNCTION WITH ALL RELEVANT DOCUMENTATION DRAWINGS AND STANDARD DETAILS BUT WITH PARTICULAR REFERENCE TO THE FOLLOWING 288933-WSP-XX-XX-DR-C-1101.

UNTIL TECHNICAL APPROVAL HAS BEEN OBTAINED FROM THE RELEVANT LOCAL AUTHORITIES OR STATUTORY BODIES, IT SHOULD BE UNDERSTOOD THAT ALL DRAWINGS ARE ISSUED AS PRELIMINARY AND NOT FOR CONSTRUCTION. SHOULD THE CONTRACTOR AND / OR EMPLOYER COMMENCE WORK PRIOR TO APPROVAL BEING GIVEN, IT IS ENTIRELY AT THEIR OWN RISK

P02	31/07/24	NR	ISSUED FOR CLIENT APPROVAL	JS	PWW	
P01	23/07/24	NR	ISSUE FOR COST ESTIMATE	JS	PWW	
DR	10/07/24	NR	DRAFT ISSUE	JS	PWW	
REV	DATE	BY	DESCRIPTION	CHK	APP	

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LINTHORPE ROAD RESTORATION


TYPICAL HIGHWAY SECTIONS

SOALL W AT.	CHLONED.		AFFROVED.		
AS SHOWN	JS		PWW		
PROJECT NO: 2024UK293315	DESIGNED:	DRAWN: NR	DATE: JULY	2024	
DRAWING No:		-		REV:	


288933-WSP-XX-XX-DR-C-1112


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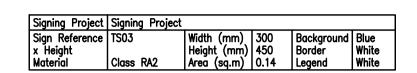
P02




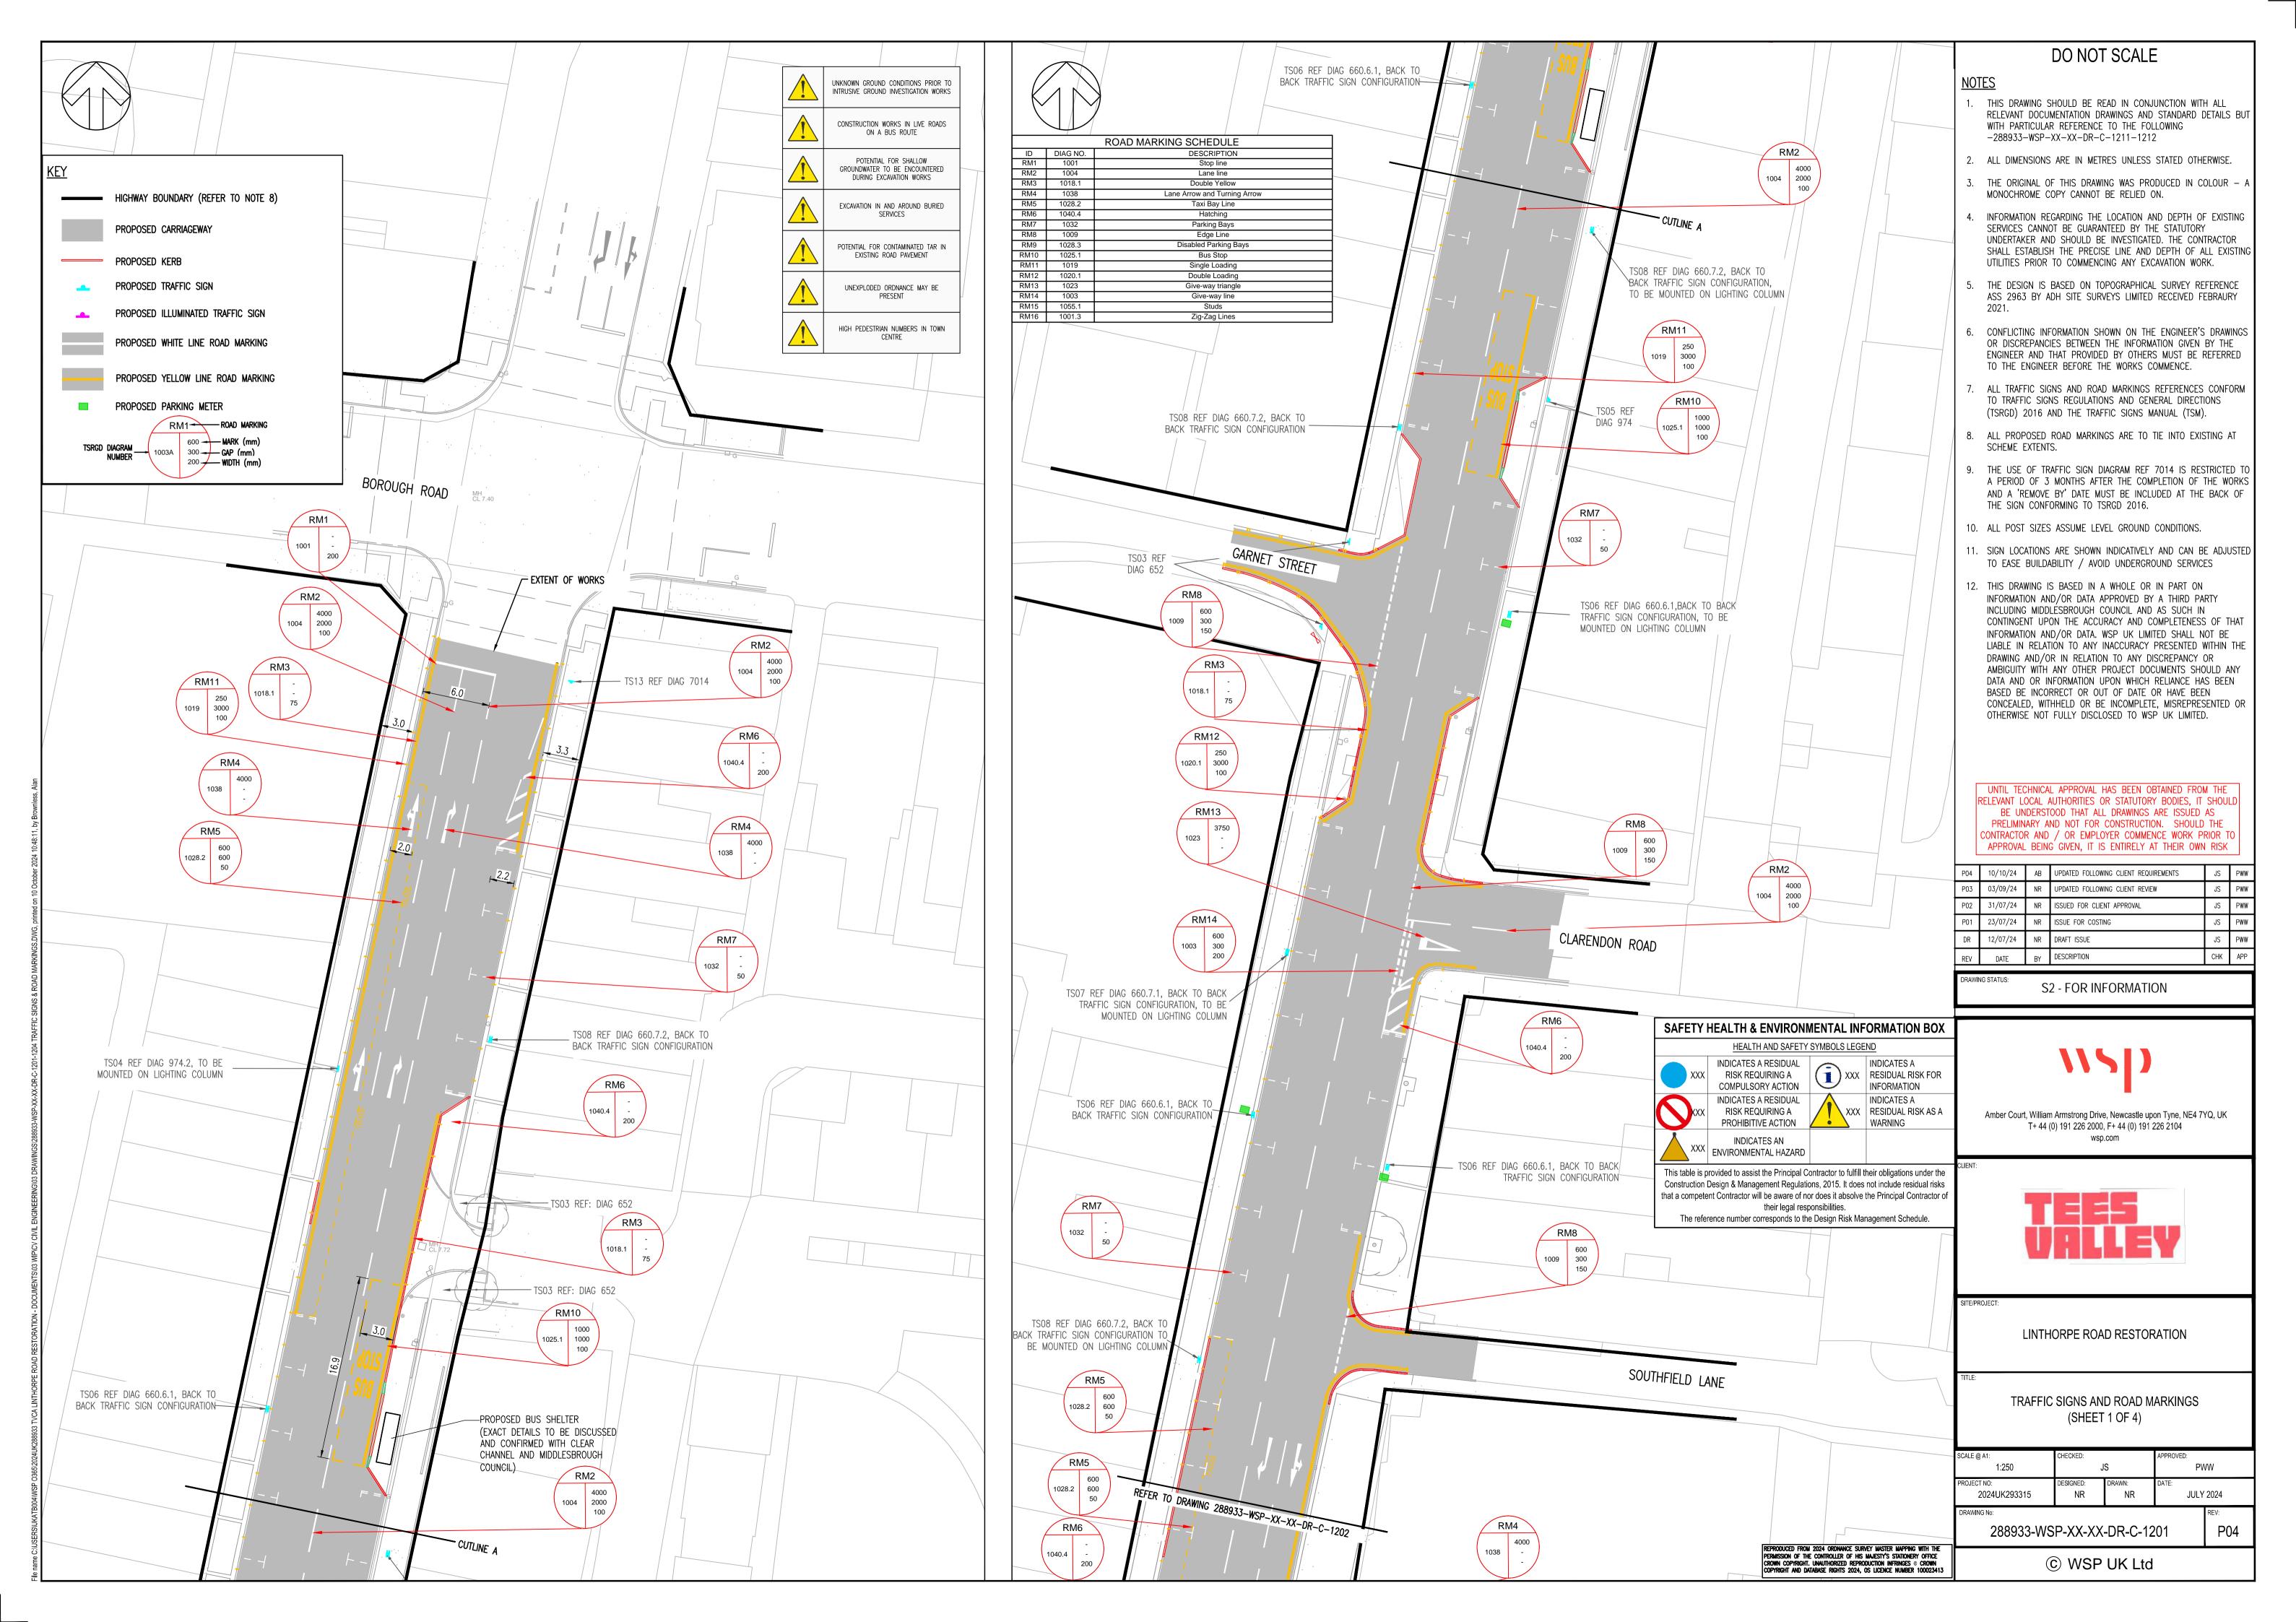



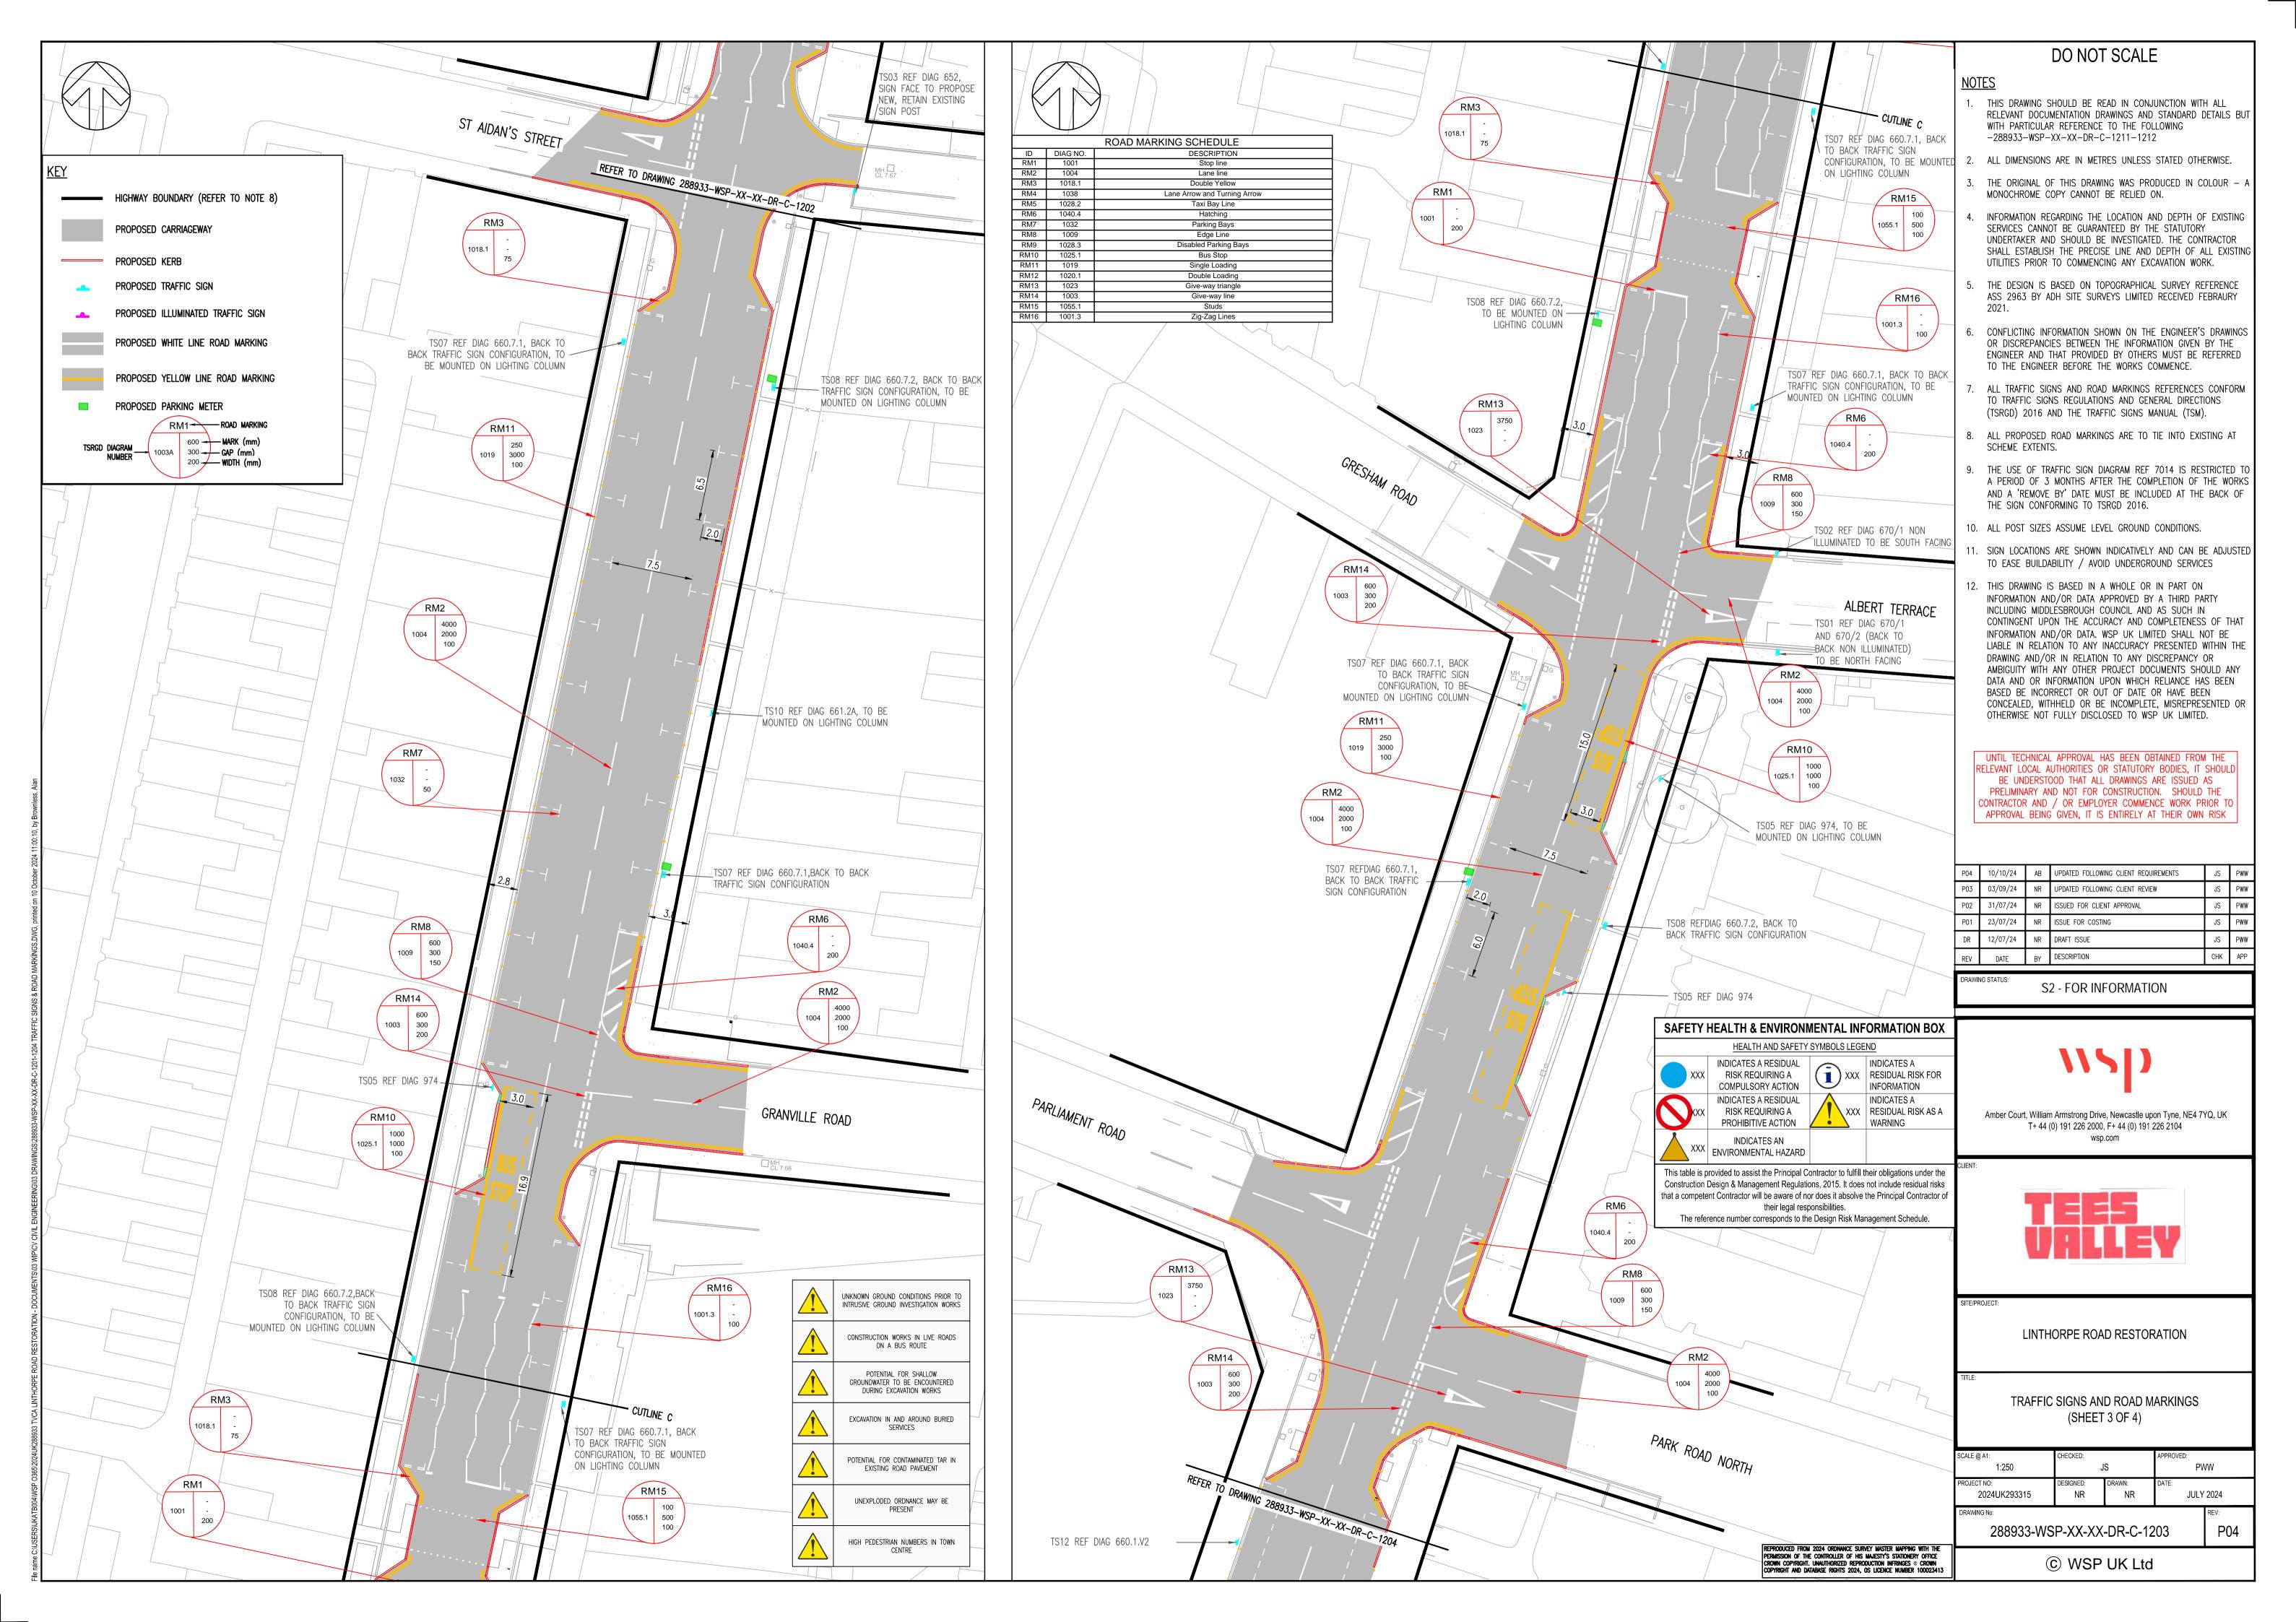

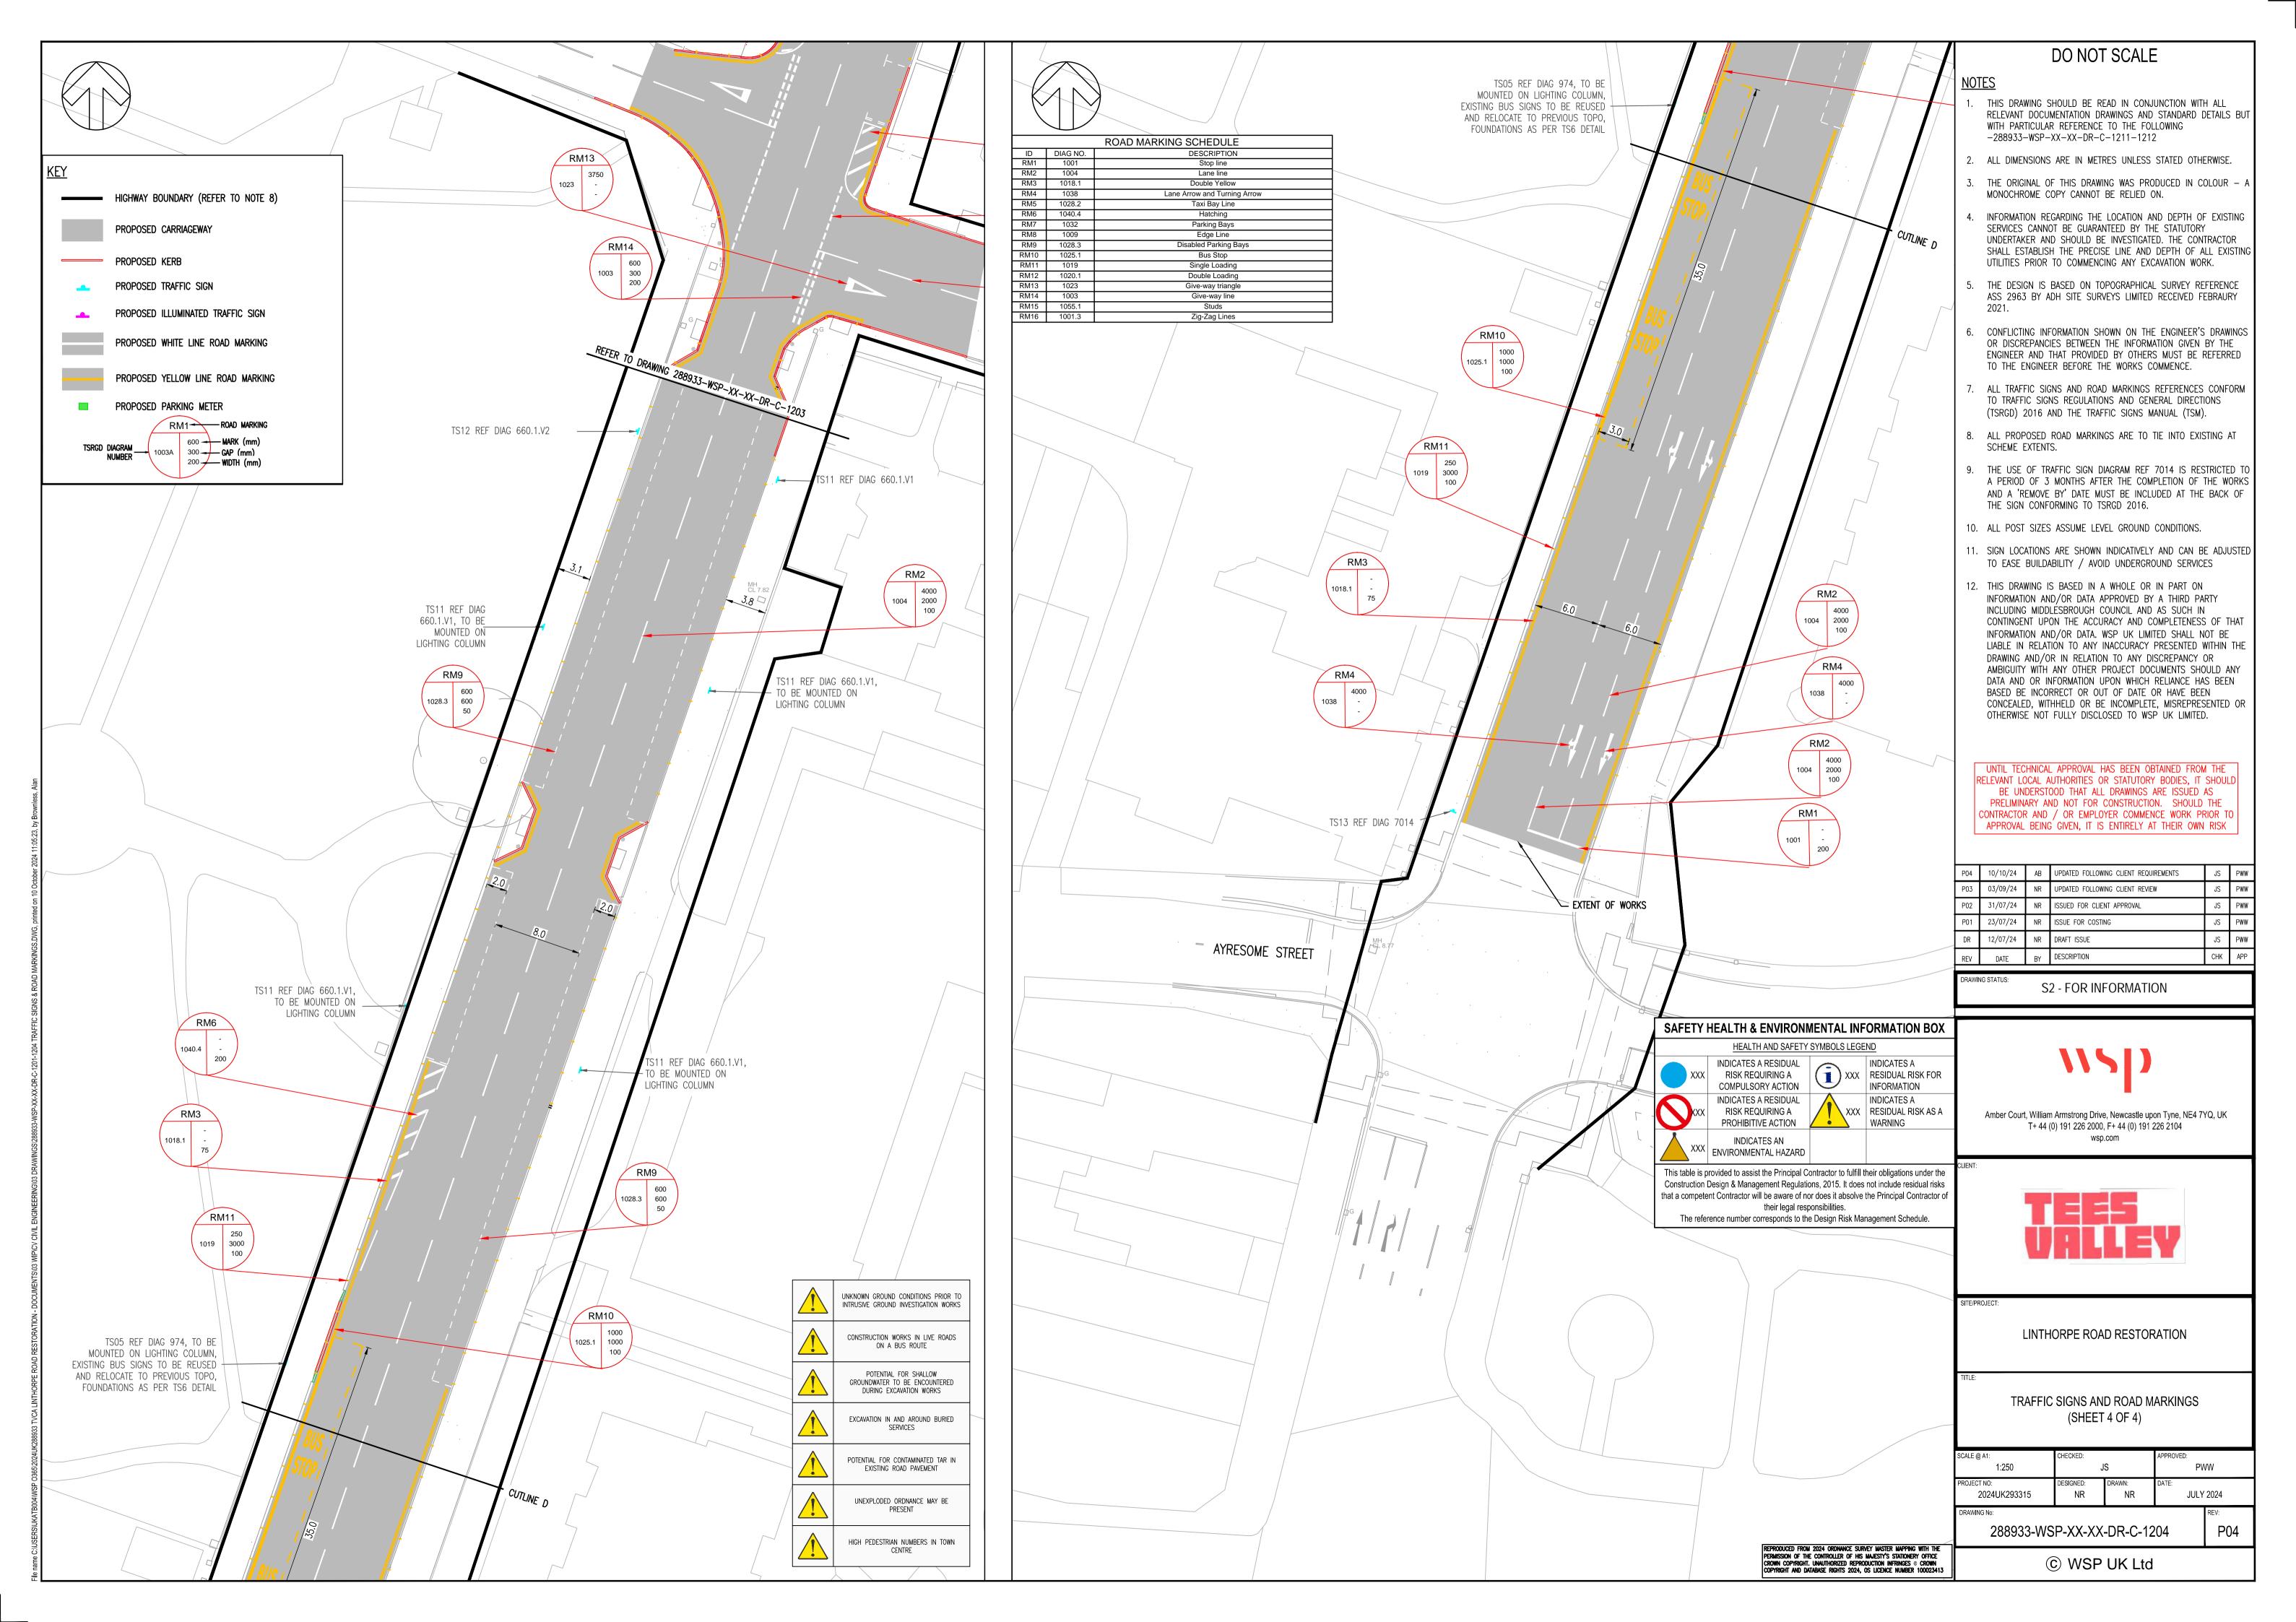


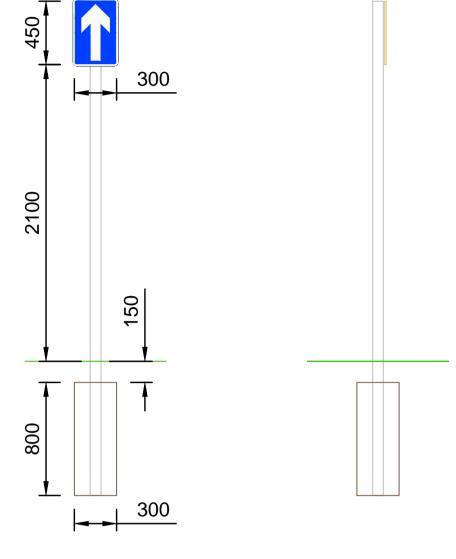

Structural Calculation Details Reference: TS03
Width: 300mm, Height: 450mm
Shape: Rectangle
Orientation: Facing front
Mounted on posts: 1
Mounting height: 2100mm, at post Quantity: 1 Type: 76.1 x 3.2 CHS (S355) Spacing: N/A Post 1 Length: 3500mm Type: Planted
Diameter: 300mm
Depth: 800mm
Volume: 0.06cu.m
Earth cover: 150mm

TS03 - 652


Signing Project	Signing Project				
	TS13 50.0 Class RA2	Width (mm) Height (mm) Area (sq.m)	450	Background Border Legend	Red White White

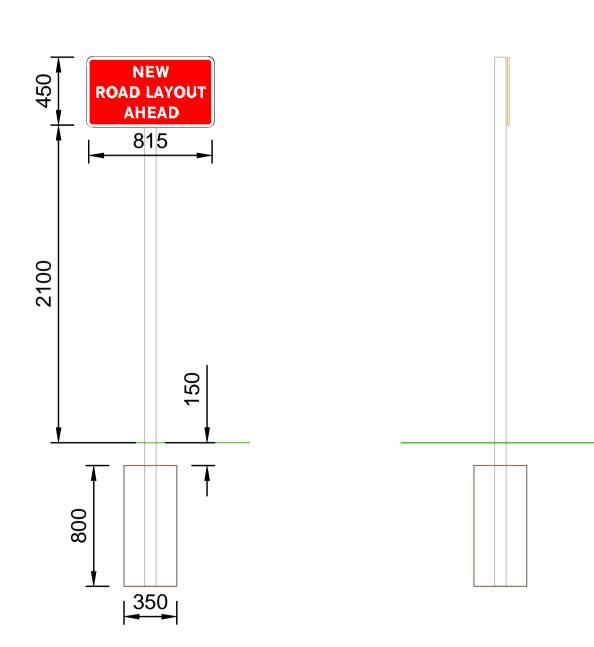

TS13 - 7014

Structural Calculation Details Reference: TS13 Width: 815mm, Height: 450mm Shape: Rectangle Orientation: Facing front Mounted on posts: 1 Mounting height: 2100mm, at post Type: 76.1 x 3.2 CHS (S355) Spacing: N/A Post 1 Length: 3500mm Type: Planted
Diameter: 350mm
Depth: 800mm Volume: 0.08cu.m Earth cover: 150mm

SIGN SCHEDULE														
Sign Reference	TSRGD NO.	x Height	Width (mm)	Height (mm)	Area (m²)	Mounting height	Post quantity	Post type	Post 1 length	Base type	Base depth	Base volume	Earth cover	Illumination
TS02	670/1	100	600	600	0.28	2100mm, at post	1	76.1 x 3.2 CHS (S355)	3770	Planted	800	0.06	150	Yes
TS04	974.2	40.0	545	415	0.23	2100mm, at post	1	76.1 x 3.2 CHS (S355)	3465	Planted	800	0.06	150	No
TS05	974.2	40.0	590	465	0.27	2100mm, at post	1	76.1 x 3.2 CHS (S355)	3515	Planted	800	0.06	150	No
TS06	660.6.1	15.0	280	455	0.13	2100mm, at post	1	76.1 x 3.2 CHS (S355)	3505	Planted	800	0.06	150	No
TS07	660.7.1	15.0	280	505	0.14	2100mm, at post	1	76.1 x 3.2 CHS (S355)	3555	Planted	800	0.06	150	No
TS08	660.7.2	15.0	280	505	0.14	2100mm, at post	1	76.1 x 3.2 CHS (S355)	3555	Planted	800	0.06	150	No
TS09	660.7.3	15.0	280	505	0.14	2100mm, at post	1	76.1 x 3.2 CHS (S355)	3555	Planted	800	0.06	150	No
TS10	661.2A	15.0	235	165	0.04	2100mm, at post	1	76.1 x 3.2 CHS (S355)	3215	Planted	800	0.06	150	No
TS11	660.1.V1	15.0	270	195	0.05	2100mm, at post	1	76.1 x 3.2 CHS (S355)	3245	Planted	800	0.06	150	No
TS12	660.1.V2	15.0	270	235	0.06	2100mm, at post	1	76.1 x 3.2 CHS (S355)	3285	Planted	800	0.06	150	No
TS13	7014	50.0	815	450	0.37	2100mm, at post	1	76.1 x 3.2 CHS (S355)	3500	Planted	800	0.08	150	No

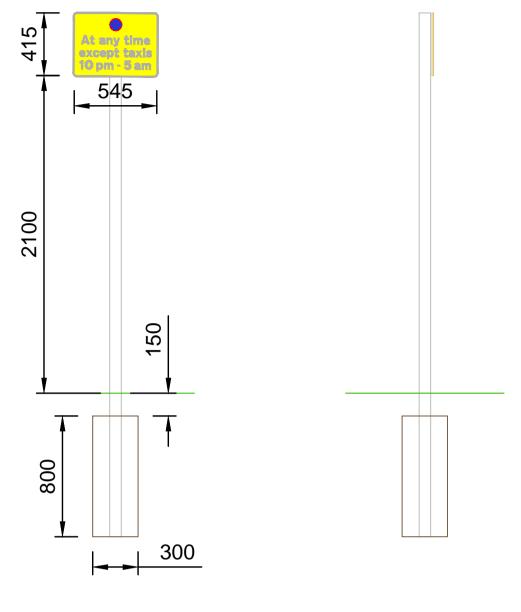

Structural Calculation Details Reference: TS04 Width: 545mm, Height: 415mm Shape: Rectangle Orientation: Facing front Mounted on posts: 1 Mounting height: 2100mm, at post Type: 76.1 x 3.2 CHS (S355) Spacing: N/A Post 1 Length: 3465mm Type: Planted
Diameter: 300mm
Depth: 800mm
Volume: 0.06cu.m Earth cover: 150mm

TS04 - 974.2

### DO NOT SCALE

- 1. ALL DIMENSIONS ARE IN METRES UNLESS OTHERWISE STATED.
- 2. ALL LEVELS ARE IN METRES ABOVE ORDNANCE DATUM.
- 3. WORKS SHALL BE CONSTRUCTED IN ACCORDANCE WITH THE RELEVANT B.S, MIDDLESBROUGH COUNCIL HIGHWAY DESIGN GUIDE AND DEPARTMENT OF TRANSPORTS 'SPECIFICATION FOR HIGHWAY WORKS', PUBLISHED BY HMSO. ALL SPECIFICATION CLAUSES REFER TO THIS DOCUMENT UNLESS OTHERWISE
- 4. ALL SETTING OUT IS TO BE AGREED WITH THE ENGINEER PRIOR TO THE COMMENCEMENT OF THE WORKS.THIS DRAWING IS TO BE READ IN CONJUNCTION WITH ALL OTHER RELEVANT DRAWINGS, SCHEDULES AND SPECIFICATIONS.
- CONFLICTING INFORMATION SHOWN ON THE ENGINEER'S DRAWINGS OR DISCREPANCIES BETWEEN THE INFORMATION GIVEN BY THE ENGINEER AND THAT PROVIDED BY OTHERS MUST BE REFERRED TO THE ENGINEER BEFORE THE WORKS COMMENCE.
- 4. TRAFFIC SIGNS & ROAD MARKING REFERENCES CONFORMS TO TSRGD 2016.
- 5. SIGN POSITIONING AND SIZES ARE NOT TO SCALE, EXACT LOCATION AND ORIENTATION OF SIGNS TO BE CONFIRMED WITH ENGINEERS REPRESENTATIVE PRIOR TO ERECTION ON SITE.
- 6. POST FOUNDATIONS SUBJECT TO FINAL DESIGN BY CONTRACTOR TO AVOID BURIED SERVICES.
- SIGNAGE LOCATED WITHIN FOOTWAYS TO HAVE A MOUNTING HEIGHT OF 2.3m;
- 8. ALL ILLUMINATED SIGNS TO BE MOUNTED ON GALVANISED WIDE BASED POSTS WITH G1 FINISH KCC COASTAL SPECIFICATION AS MANUFACTURED BY STAINTON FABRIKAT.
- 9. ALL SIGN LIGHTING UNITS TO BE LED LUA RANGE (TO INCLUDE PHOTOCELL): 3W FOR SMALL PLATES (600MM AND UNDER), 8W FOR LARGE PLATES (OVER 600MM) AS MANUFACTURED BY SIMMONSIGNS.
- 10. ALL ILLUMINATED AND NON-ILLUMINATED SIGN FACES TO BE CLASS 2 REFLECTIVE.
- 11. NON-ILLUMINATED TRAFFIC BOLLARDS TO BE METRO PLUS ANTI-TWIST (REFLEX BOLLARD) AS MANUFACTURED BY TMP.

P03	10/10/24	AB	UPDATED FOLLOWING CLIENT REQUIREMENTS	JS	PWW
P02	31/07/24	NR	ISSUED FOR CLIENT APPROVAL	JS	PWW
P01	23/07/24	NR	ISSUE FOR COST ESTIMATE	JS	PWW
DR	15/07/24	NR	DRAFT ISSUE	JS	PWW
REV	DATE	BY	DESCRIPTION	CHK	APP

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LINTHORPE ROAD RESTORATION

TRAFFIC SIGN DETAILS (SHEET 1 OF 3)

CALE @ A1:	CHECKED:		APPROVED:		
NTS	J	S	PWW		
ROJECT NO: 2024UK293315	DESIGNED: NR	DRAWN: NR	DATE: JULY 2024		
DRAWING No.			DEV.		

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288933-WSP-XX-XX-DR-C-1211

P03

### **Document & Drawing Issue Sheet**

Project No: 2024UK288933

Project Name: TVCA Linthorpe Road Restoration

Date of Issue: 10-Oct-2024
Purpose of Issue: Client Approval

Method of Issue Email
Number of items Issued: 28
Format of Issue: PDF
Service: DI

Issue No: 5
Issuing Office:
#N/A

Issued to:	1			
Company	Name	Position/Function		
Tees Valley Combined Authority	Craig MacLennan			

Dwg/Doc Number	Title	Scale	Size	Revision
288933-WSP-XX-XX-DR-C-0101	General Arrangement (Sheet 1 of 4)	1:250	A1	P04
288933-WSP-XX-XX-DR-C-0102	General Arrangement (Sheet 2 of 4)	1:250	A1	P04
288933-WSP-XX-XX-DR-C-0103	General Arrangement (Sheet 3 of 4)	1:250	A1	P04
288933-WSP-XX-XX-DR-C-0104	General Arrangement (Sheet 4 of 4)	1:250	A1	P04
288933-WSP-XX-XX-DR-C-0151	Setting Out (Sheet 1 of 4)	1:250	A1	P02
288933-WSP-XX-XX-DR-C-0152	Setting Out (Sheet 2 of 4)	1:250	A1	P02
288933-WSP-XX-XX-DR-C-0153	Setting Out (Sheet 3 of 4)	1:250	A1	P02
288933-WSP-XX-XX-DR-C-0154	Setting Out (Sheet 4 of 4)	1:250	A1	P02
288933-WSP-XX-XX-DR-C-0155	Setting Out	1:250	A1	P02
288933-WSP-XX-XX-DR-C-0201	Site Clearance (Sheet 1 of 4)	1:250	A1	P04
288933-WSP-XX-XX-DR-C-0202	Site Clearance (Sheet 2 of 4)	1:250	A1	P04
288933-WSP-XX-XX-DR-C-0203	Site Clearance (Sheet 3 of 4)	1:250	A1	P04
288933-WSP-XX-XX-DR-C-0204	Site Clearance (Sheet 4 of 4)	1:250	A1	P04
288933-WSP-XX-XX-DR-C-0501	Drainage Layout (Sheet 1 of 4)	1:250	A1	P04
288933-WSP-XX-XX-DR-C-0502	Drainage Layout (Sheet 1 of 4)	1:250	A1	P04
288933-WSP-XX-XX-DR-C-0503	Drainage Layout (Sheet 1 of 4)	1:250	A1	P04
288933-WSP-XX-XX-DR-C-0504	Drainage Layout (Sheet 1 of 4)	1:250	A1	P04
288933-WSP-XX-XX-DR-C-1101	Kerbs, Footways & Paved Areas (Sheet 1 of 4)	1:250	A1	P04
288933-WSP-XX-XX-DR-C-1102	Kerbs, Footways & Paved Areas (Sheet 2 of 4)	1:250	A1	P04
288933-WSP-XX-XX-DR-C-1103	Kerbs, Footways & Paved Areas (Sheet 3 of 4)	1:250	A1	P04
288933-WSP-XX-XX-DR-C-1104	Kerbs, Footways & Paved Areas (Sheet 4 of 4)	1:250	A1	P04
288933-WSP-XX-XX-DR-C-1201	Traffic Signs & Road Markings (Sheet 1 of 4)	1:250	A1	P04
288933-WSP-XX-XX-DR-C-1202	Traffic Signs & Road Markings (Sheet 2 of 4)	1:250	A1	P04
288933-WSP-XX-XX-DR-C-1203	Traffic Signs & Road Markings (Sheet 3 of 4)	1:250	A1	P04
288933-WSP-XX-XX-DR-C-1204	Traffic Signs & Road Markings (Sheet 4 of 4)	1:250	A1	P04
288933-WSP-XX-XX-DR-C-1211	Traffic Sign Details (Sheet 1 of 3)	NTS	A1	P03
288933-WSP-XX-XX-DR-C-1212	Traffic Sign Details (Sheet 2 of 3)	NTS	A1	P03
288933-WSP-XX-XX-DR-C-1213	Traffic Sign Details (Sheet 3 of 3)	NTS	A1	P03